City Hall: 218-692-2688

Planning & Zoning: 218-692-2689

Fax: 218-692-2687



13888 Daggett Bay Rd Crosslake, Minnesota 56442 www.cityofcrosslake.org

CITY OF CROSSLAKE PLANNING COMMISSION/BOARD OF ADJUSTMENT October 22, 2025 9:00 A.M.

Crosslake City Hall 13888 Daggett Bay Rd, Crosslake MN 56442 (218) 692-2689

PUBLIC HEARING NOTICE

Applicant: Darrin Alan & Amanda Kay Drews Trust

Site Location: 37223 Twin Bay Dr, Crosslake, MN 56442 on Rush Lake-GD

Variance for:

- Lake setback of 63 feet where 75 feet is required to proposed dwelling
- Side yard setback of 7.2 feet where 10 feet is required to proposed dwelling
- Road right-of-way setback of 14.2 feet where 35 feet is required to proposed dwelling
- Road right-of-way setback of 3.2 feet where 10 feet is required for proposed septic system
- Side yard setback of 4.0 feet where 10 feet is required for the proposed septic system
- Drainfield setback of 11.5 feet where 20 feet is required for the proposed dwelling
- Road right-of-way setback of 17.0 feet where 35 feet is required to the proposed patio

To construct:

- Ground cover of 2,107 square foot (sf) 3 level dwelling including a 2-story attached garage
- 144 square foot deck
- 198 square foot patio/walkway
- New updated septic system

Notification: Pursuant to Minnesota Statutes Chapter 462, and the City of Crosslake Zoning Ordinance, you are hereby notified of a public hearing before the City of Crosslake Planning Commission/Board of Adjustment. Property owners have been notified according to MN State Statute 462 & published in the local newspaper. Please share this notice with any of your neighbors who may not have been notified by mail.

Information: Copies of the application and all maps, diagrams or documents are available at Crosslake City Hall or by contacting the Crosslake Planning & Zoning staff at 218-692-2689. Please submit your comments in writing including your name and mailing address to Crosslake City Hall or (crosslakepz@cityofcrosslake.org).



STAFF REPORT

Property Owner/Applicant: Darrin Alan & Amanda Kay Drews Trust

Parcel Number(s): 14070610

Application Submitted: September 8, 2025

Action Deadline: November 7, 2025

City 60 Day Extension Letter sent / Deadline: NA / NA

Applicant Extension Received / Request: NA / NA

City Council Date: NA

Authorized Agent: Wes Hanson Builders/Matthew Schmidt

Variance for:

• Lake setback of 63 feet where 75 feet is required to proposed dwelling

- Side yard setback of 7.2 feet where 10 feet is required to proposed dwelling
- Road right-of-way setback of 14.2 feet where 35 feet is required to proposed dwelling
- Road right-of-way setback of 3.2 feet where 10 feet is required for proposed septic system
- Side yard setback of 4.0 feet where 10 feet is required for the proposed septic system
- Drainfield setback of 11.5 feet where 20 feet is required for the proposed dwelling
- Road right-of-way setback of 17.0 feet where 35 feet is required to the proposed patio

To construct:

- Ground cover of 2,107 square foot (sf) 3 level dwelling including a 2-story attached garage
- 144 square foot deck
- 198 square foot patio/walkway
- New updated septic system

Current Zoning: Shoreland District

Existing Impervious Coverage:

Proposed Impervious Coverage:

27.5%

25%

- A stormwater management plan was submitted with the variance application
- Compliant septic compliance inspection on file dated 8-13-2025
- Septic design was submitted

Parcel History:

- Anderson's Twin Bay Shores established in 1967
- September 1980 288 sf deck
- October 1991 Variance denied for road right-of-way setback for garage
- May 1992 Variance approved for road right-of-way setback for garage
- May 1992 26x32 garage & septic
- September 2004 Driveway

• August 2012 – Sand blanket

Agencies Notified and Responses Received:

County Highway Dept: N/A

DNR: No comment received before packet cutoff date

City Engineer: N/A

Lake Association: No comment received before packet cutoff date

Crosslake Public Works: No comment received before packet cutoff date

Crosslake Park, Recreation & Library: N/A

Concerned Parties: No comment received before packet cutoff date

POSSIBLE MOTION:

To approve/table/deny the variance to allow:

- Lake setback of 63 feet where 75 feet is required to proposed dwelling
- Side yard setback of 7.2 feet where 10 feet is required to proposed dwelling
- Road right-of-way setback of 14.2 feet where 35 feet is required to proposed dwelling
- Road right-of-way setback of 3.2 feet where 10 feet is required for proposed septic system
- Side yard setback of 4.0 feet where 10 feet is required for the proposed septic system
- Drainfield setback of 11.5 feet where 20 feet is required for the proposed dwelling
- Road right-of-way setback of 17.0 feet where 35 feet is required to the proposed patio

To construct:


- Ground cover of 2,107 square foot (sf) 3 level dwelling including a 2-story attached garage
- 144 square foot deck
- 198 square foot patio/walkway
- New updated septic system

As shown on the certificate of survey dated 10-1-2025



CERTIFICATE OF SURVEY

LOT 17, BLOCK 1, ANDERSON'S TWIN BAY SHORES, SECTION 7, TOWNSHIP 137 NORTH, RANGE 27 WEST, CITY OF CROSSLAKE, CROW WING COUNTY, MINNESOTA TOTAL AREA = $12,291 \text{ SQ.FT} \pm / 0.28 \text{ ACRES} \pm$

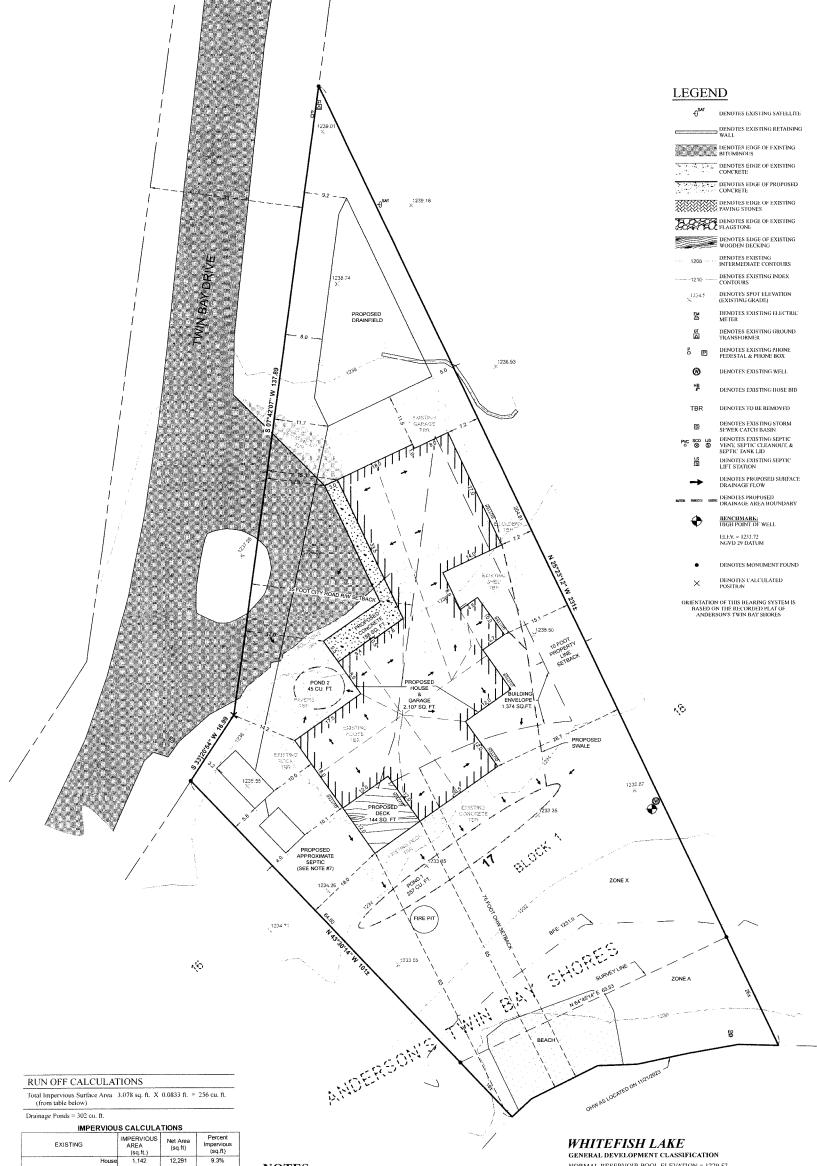

IMPERVIOU	S CALCULA	TIONS		
EXISTING	IMPERVIOUS AREA (sq.ft.)	Net Area (sq.ft)	Percent Impervious (sq.ft)	
House	1,142	12,291	9.3%	
Garage	850	12,291	6.9%	
Shed	66	12,291	0.5%	
Concrete, Pavers, & Flagstone	329	12,291	2.7%	
Bituminous Driveway	997	12,291	8.1%	
Total	3,384	12,291	27.5%	

IMPERVIOUS CALCULATIONS					
PROPOSED	IMPERVIOUS AREA (sq.ff.)	Net Area (sq.ft)	Percent Impervious (sq.ft)		
Proposed House & Garage	2,107	12,291	17.1%		
Proposed Concrete	198	12,291	1.6%		
Proposed Bituminous Driveway	773	12,291	6.3%		
Total	3,078	12,291	25.0%		

NOTES:

- Contour interval as shown = 2 foot. Based on NGVD 29 datum. Contours shown have been obtained using standard survey topographic methodologies. Field located on 11/21/2023.
- Zoning for subject tract and adjacent properties = "SHORELAND DISTRICT".

- Zoning for subject tract and adjacent properties = "SHORELAND DISTRICT".
 Parcel ID of subject parcel: 14070610.
 The E911 address of subject parcel: 37223 Twin Bay Drive.
 Setbacks as shown can be subject to interpretation. Verification of setbacks by the governing body is advised prior to building.
 Property is in "Zone X" and "Zone A" as per the FIRM. Flood Insurance Rate Map. "Zone A" definition: Areas of 100-year flood base elevations and flood hazard factors not determined. "Zone X" definition: Areas of minimal flooding.


- 7. Proposed septic design provided by Lakes Area Septic Design & Inspection.
 8. No wetlands were found on 9/3/2025 at the site per Ben Meister, Meister Environmental, LLC. MM Certified Wetland Delineator #1031.

 9. Dirtwork Calculation: No additional dirt moving will occur outside of proposed building footprint. Therefore, net cut and fill = 0 cu. yd.

NORMAL RESERVOIR POOL ELEVATION = 1229.57

100 YEAR FLOOD ELEVATION = 1231.00 HIGHEST KNOWN ELEVATION = 1234.56

INFORMATION OBTAINED FROM CORPS OF ENGINEERS LAKE ELEVATION = 1228.75 ON 11-21-2023 NGVD 29 DATUM

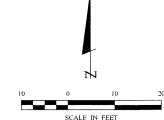

SCALE IN FEET ON 22" X 34" SHEET


CERTIFICATE OF SURVEY Drews Property DATE DATE DESCRIPTION

B2023 AMENDMENTS PER CITY COMMENTS

G10225 AMENDMENTS PER CITY COMMENTS UNDER THE LAWS OF THE STATE OF MINNE PATRICK A. TROTTIER PLS#41002 fom Hanson 2 Wes Hanson Builders 13645 North Horseshoe Lake Road Merrifield, MN 65465 C25173.DWG $IORZ, \quad 1^{st} = 10^{t}$ 10.01.2025 ERT. NONE



30206 Rasmussen Road Suite 1 P. O. Box 874 Pequot Lakes, MN 56472 218-568-4940 www.stonemarksurvey.com

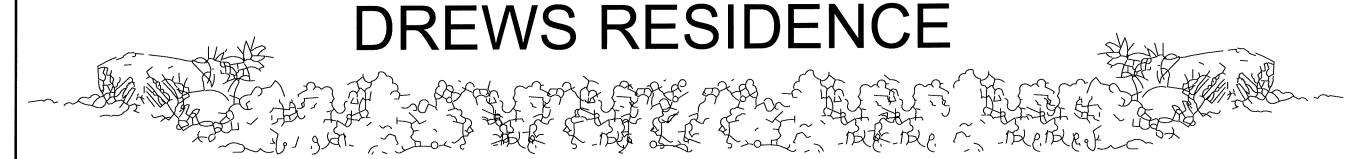

37223 TWIN BAY DRIVE CROSSLAKE, MN 56442

BID NOTES:

GENERAL NOTES:
1.) BID OPTION = FINISHED LOWER LEVEL

3) RUN GAS LINE TO GRILL

1.) STONE - THIN CUT STONE VENEER (STYLE TBD)

2.) SIDING
- L.P. SMARTSIDE TEXTURED - SMOOTH - 5.84" - 7.84" - 11.84" LAP (4 7/8" -

5 7/8" - 6 7/8" - 10 7/8" ?" REVEAL) - PAINTED (COLOR TBD)
- L.P. SMARTSIDE SHAKES TEXTURED - SMOOTH (STAGGERED - STRAIGHT

EDGE) - PAINTED (COLOR TBD) - L.P. SMARTSIDE - HARDY BRD - WOOD - BOARD + BATTEN

- WOOD SIDING ? WIDTH ? REVEAL?

- CORNER TRIM

- 540x8 L.P. SMARTSIDE TRIM

- DOOR AND WINDOW

HEADS = 2 X 6 (RUN 1" PAST SIDES) 540 X 6 LP - SIDES / APRON = 2 X 6

· SILLS = 2 X 4 @ 15 DEGREE ANGLE (RUN 1" PAST SIDES) - BTM FRIEZE = 2 X 8 - MID FRIEZE = 2 X 6 W/ 2 X 4 ON TOP @ 15 DEGREE ANGLE - GABLE & SHED FRIEZE = 2 X 4

- MARVIN ELEVATE (COLOR = BLACK) - MARVIN ULTIMATE PATIO DOORS (COLOR = BLACK)

EXT - BLACK

HARDWARE - ALMOND FROST

SCREEN SURROUND - ALMOND FROST

5.) DOORS - SEE SCHEDULES FOR DETAILS

- HARDWARE = EMTEK (FLAT BLACK) - MAIN ENTRY = 6'-0" X 8'-0", HALF-LITE, 36" DOOR W/2 18" SIDELITES

- MAIN EIN RT = 6-0 X 6-0 , TALE-LITE, 35 DOOR WIZ 16
- 2 WIDE / 2 HIGH GRID IN GLASS (KNOTTY ALDER)
- COMMON DOOR = 3-0' X 6-8", 2-PANEL, RAISED
- 20 MIN FIRE-RATED (INSULATED STEEL)

- 20 MIN FIRE-RATED (INSOLATED STEEL)
- GARAGE SERVICE (X2) = 3'-0" X 8'-0" HALF-LITE,
- 2 WIDE / 2 HIGH GRID IN GLASS (KNOTTY ALDER)
- OTHER DOORS = LL, ML 2'-8" X 6'-8" HALF-LITE

- LP OR WOOD OR ALUMINUM - 1x6 V-JOINT - PINE (STAINED)

- VENT = 3" CONTINUOUS ALUMINUM (BLACK)

- RS CEDAR - 2 PIECE / 1x2 OVER 1/2x8 (COLOR TBD)

- TIMBERLINE H.D. SHINGLE (COLOR = CHARCOAL)

- STANDING SEAM METAL (COLOR = EBONY)

9.) DECKING
- AZEK - TREX (COLOR = TBD)

10.) DECK RAILING
- STAINED CEDAR 2x4 TOP AND BOTTOM RAIL (COLOR TBD) 3/4" ALUMINUM SPINDLE

METAL RAIL - BULLET RAIL?

11.) BRACKETS & POSTS

- STAINED R.S. CEDAR (COLOR TBD) - METAL

INSULATION:
1.) FOUNDATION WALLS - SLAB OR FLOOR TRUSS/JOISTS?

- 2" RIGID INSUL. @ EXTERIOR - SPRAY FOAM @ INTERIOR 2.) FLOOR RIM - SLAB OR FLOOR TRUSS/JOISTS? - SPRAY FOAM

-MAIN LEVEL FLOOR
- SOUND BATT INSUL. OVER LOWER LEVEL BEDROOMS
- UPPER & LOWER LEVEL FLOOR

- SOUND BATT INSUL. @ BEDROOMS
5.) EXTERIOR WD. FRAMED WALLS

- R-24 BLOWN-IN BLANKET

- SOUND BATT - SEE PLANS

7.) ATTIC - R-50 BLOWN-IN

SMOOTH OR MEDIUM KNOCKDOWN CEILING

- WOOD - 5" RED / WHITE OAK W/ LIGHT BAND-SAW MARKS - STAINED W/ SATIN SHEEN

- LVP (STYLE + COLOR) - TILE (SIZE, STYLE, COLOR - ALLOWANCE)

- CARPET - STAIRS TREADS

- MATERIAL = KNOTTY ALDER - FIR - POPLAR

- STICKING = TAPERED SQUARE ?

FINISH = PAINTED OR STAINED (COLOR TBD) 4.) DOOR HARDWARE

BRAND = EMTEK

- STYLE = LEVER

- HINGES = SQUARE - BLACK

- HEAD = 5/4" X 5 1/2" (RUN 3/4" PAST SIDES)

- SIDES = 3/4" X 3 1/2" - SILL = 5/4" X 1 1/2" (RUN 3/4" PAST SIDES)

- APRON = 3/4" X 3 1/2" - BASE = 5/8" X 5 1/2" ON MAIN LEVEL,

5/8" X 5 1/2" ON UPPER LEVEL 6.) PAINTING / STAINING

INTING / STAINING - STAINED WINDOW, DOOR AND BASE TRIM (COLOR TBD) - STAINED INTERIOR DOORS (COLOR TBD)

BEAMS, STAIR PARTS, WOOD CEILINGS?

- PAINTED ?

- 6 X 6 PINE NEWELS W/ 2 X 6 PINE TOP RAIL - METAL - WROUGHT IRON SPINDLES

- DOOR STYLE = FLAT - RAISED - SHAKER PANEL

- DOWNSTILE - FLAT - MAISEY - SMARK FAVEL
- DRAWER STYLE = 5-PIECE WHERE APPLICABLE
- DRAWER BOXES = WOOD / DOVETAIL
- FINISH = PAINT - STAINED - GRADE MAPLE - POPLAR (TBD)
- OVERLAY = 3/4"

- SOFT CLOSE - INTERIORS = WHITE, MELAMINE

2.) TYPICAL CABINET

- DOOR STYLE = FLAT PANEL - DRAWER STYLE = 5-PIECE WHERE APPLICABLE

- DRAWER BOXES = WOOD / DOVETAIL - FINISH = PAINT - STAINED - GRADE MAPLE - POPLAR (TBD)

- SOFT CLOSE

INTERIORS = WHITE, MELAMINE

COUNTERTOPS: 1.) GRANITE (LVL 5) = 2) GRANITE REMNANT =

3.) CULTURED MARBLE =

4) I AMINATE =

BACKSPLASH:
TILE = KITCHEN, WET BAR (MATCH COUNTERTOP)

- HEAT-N-GLO 36" EXCLAIM GAS BURNING INSERT

THIN STONE VENEER FACE

- RAISED HEARTH (MATERIAL TBD) WOOD MANTEL

2.) LL FAMILY ROOM

- WOOD BURNING INSERT - THIN STONE VENEER

- FLUSHED HEARTH (MATERIAL TBD)

WOOD MANTEL

PLUMBING:

1.) SEE ELECTRICAL SHEETS FOR DETAILS 2.) SINKS

- UNDERMOUNT (GRANITE)

- INTEGRATED (C. MARBLE) - DROP-IN (LAMINATE)

FAUCETS / FIXTURES = CHROME FINISH

- TILE = MASTER - TUB/SHOWER INSERT = LL + U.L. BATH

HVAC:
1.) SEE ELECTICAL SHEETS FOR DETAILS

ELECTRICAL:

1.) SEE ELECTRICAL SHEETS FOR DETAILS

SHEET INDEX			
Sheet Number	SHEET NAME		
T0.0	TITLE SHEET		
	CERTIFICATE OF SURVEY		
A0.1	ARCHITECTURAL SITE PLAN		
A0.2	STORMWATER MANAGEMENT PLAN		
A1.0	FOUNDATION PLAN		
A1.1	LOWER LEVEL FLOOR PLAN		
A1.2	MAIN LEVEL FLOOR PLAN		
A1.3	UPPER LEVEL FLOOR PLAN		
A1.4	ROOF PLAN		
A2.1	EXTERIOR ELEVATION		
A2.2	EXTERIOR ELEVATION		
A2.3	EXTERIOR ELEVATION		
A2.4	EXTERIOR ELEVATION		
A3.2	BUILDING SECTIONS		
A5.1	PERSPECTIVES		
E1.0	LOWER LEVEL ELECTRICAL PLAN		
E1.1	MAIN LEVEL ELECTRICAL PLAN		
E1.2	UPPER LEVEL ELECTRICAL PLAN		

SHEET INDEX			
Sheet Number	SHEET NAME		
.0	TITLE SHEET		
	CERTIFICATE OF SURVEY		
.1	ARCHITECTURAL SITE PLAN		
.2	STORMWATER MANAGEMENT PLAN		
.0	FOUNDATION PLAN		
.1	LOWER LEVEL FLOOR PLAN		
.2	MAIN LEVEL FLOOR PLAN		
.3	UPPER LEVEL FLOOR PLAN		
.4	ROOF PLAN		
.1	EXTERIOR ELEVATION		
.2	EXTERIOR ELEVATION		
.3	EXTERIOR ELEVATION		
.4	EXTERIOR ELEVATION		
.2	BUILDING SECTIONS		
.1	PERSPECTIVES		
.0	LOWER LEVEL ELECTRICAL PLAN		
.1	MAIN LEVEL ELECTRICAL PLAN		
.2	UPPER LEVEL ELECTRICAL PLAN		
	4		


DRAWN BY: CHECKED BY: MWS DATE: 8-29-25


DREWS RESIDENCE DREWS DARRIN & AMANDA 37223 TWIN BAY DRIVE CROS


WES HANSON


T0.0

PROPERTY OF WES HANSON BUILDERS, INC.

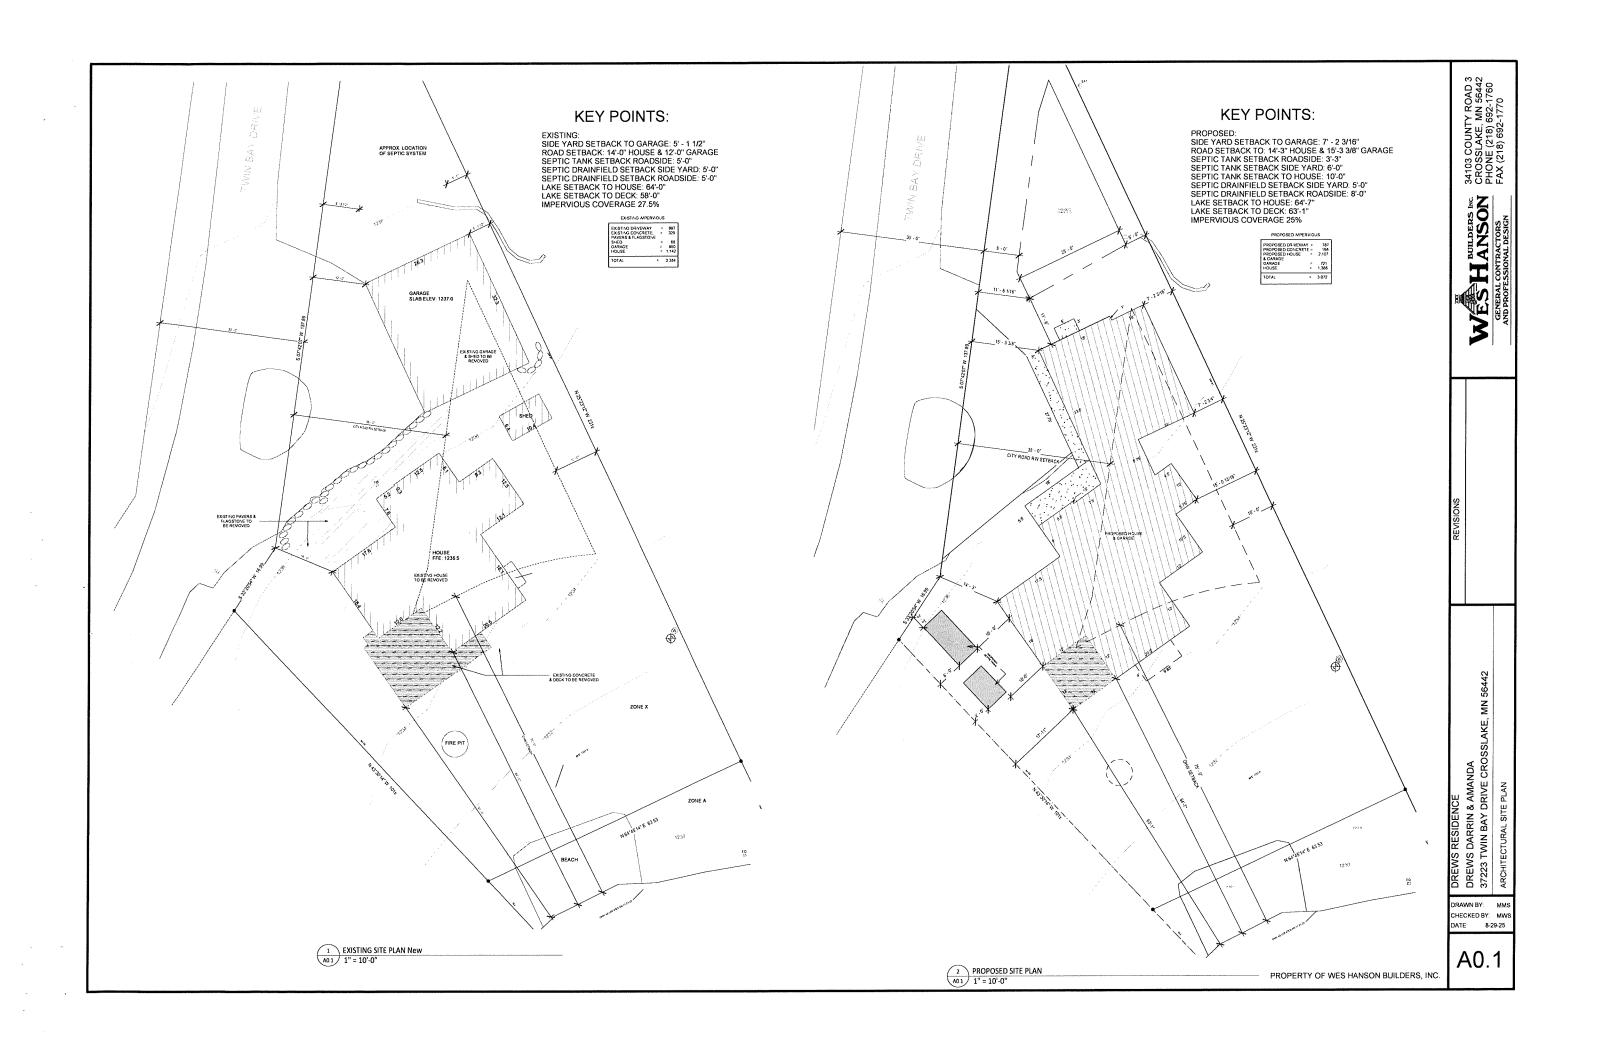

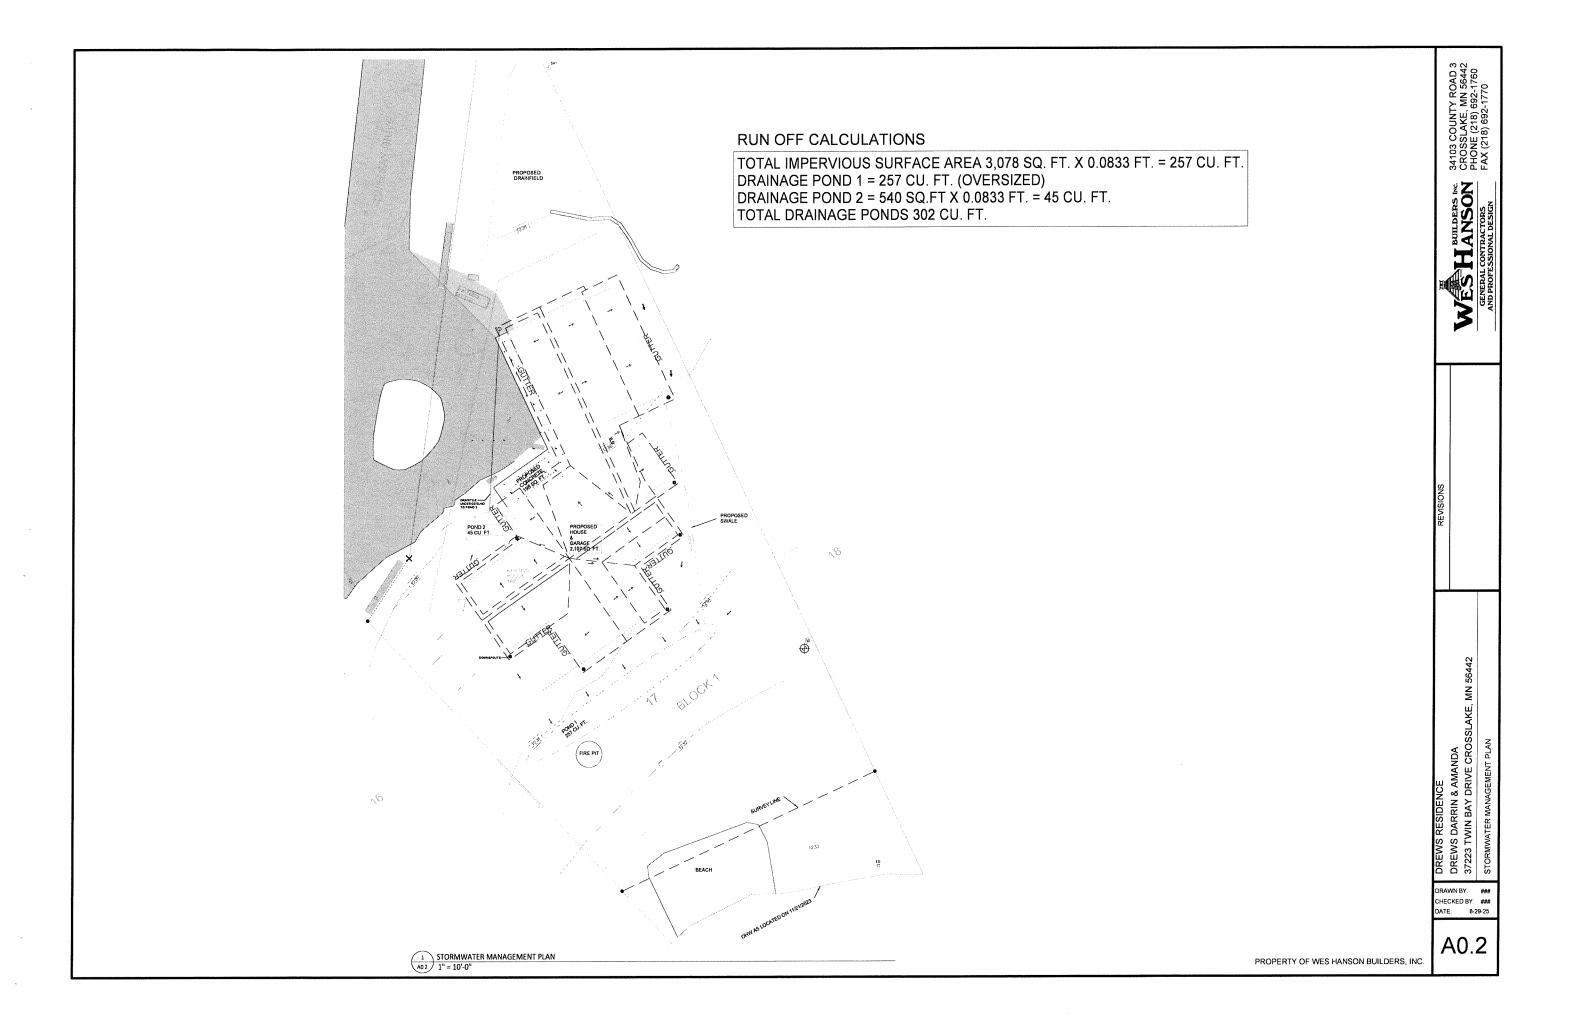

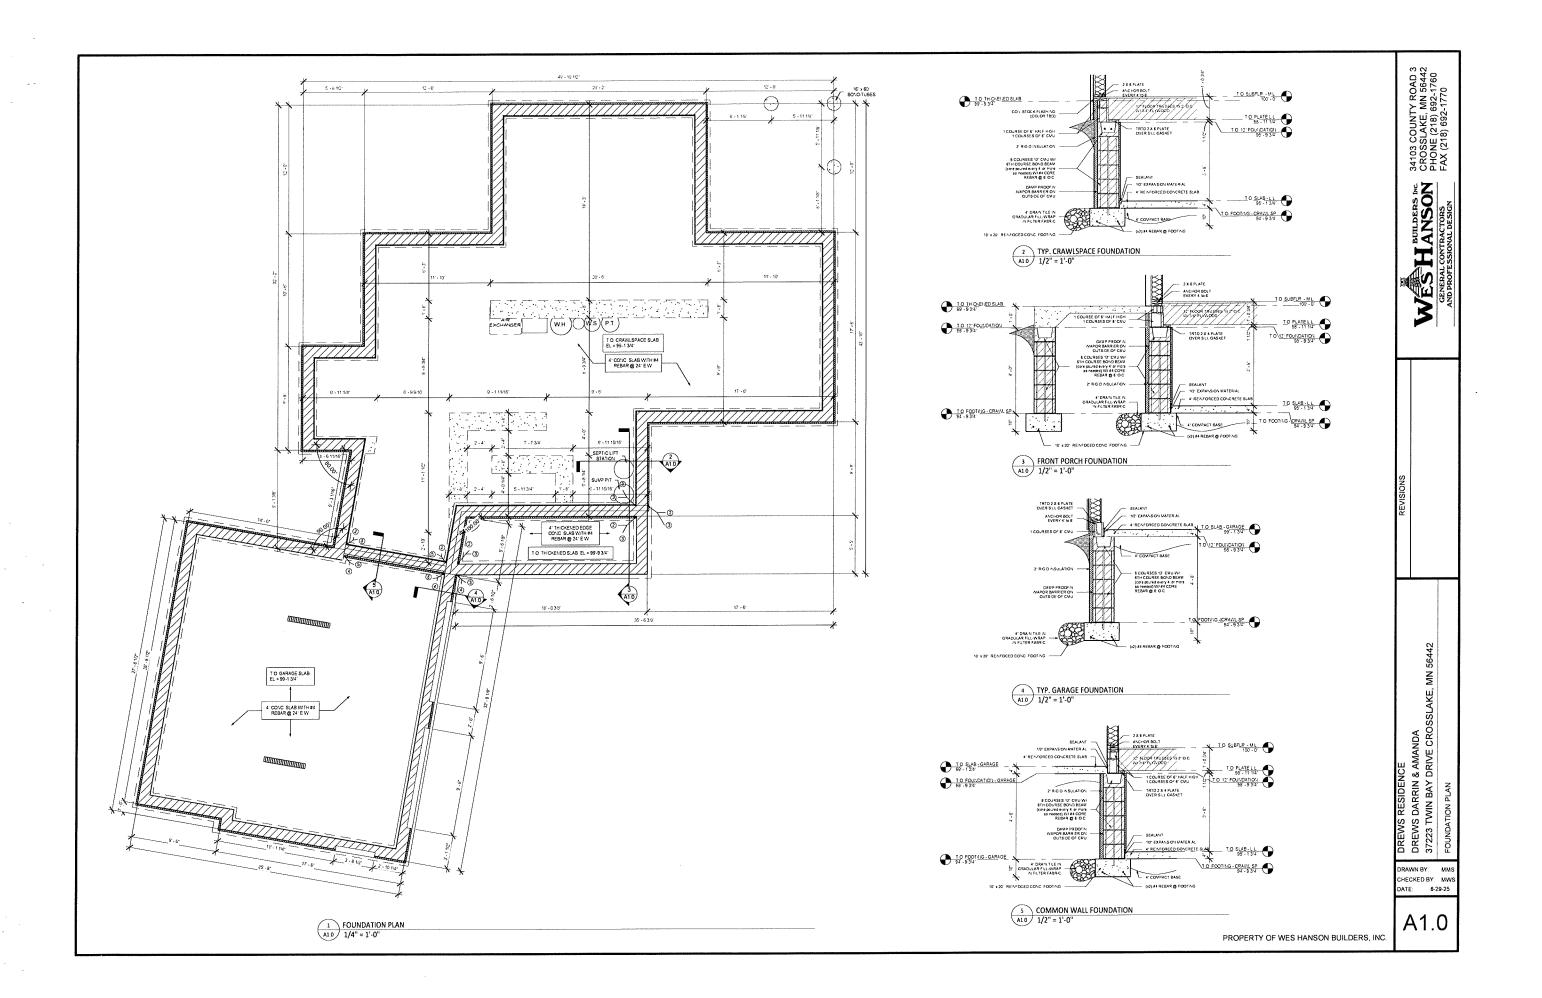

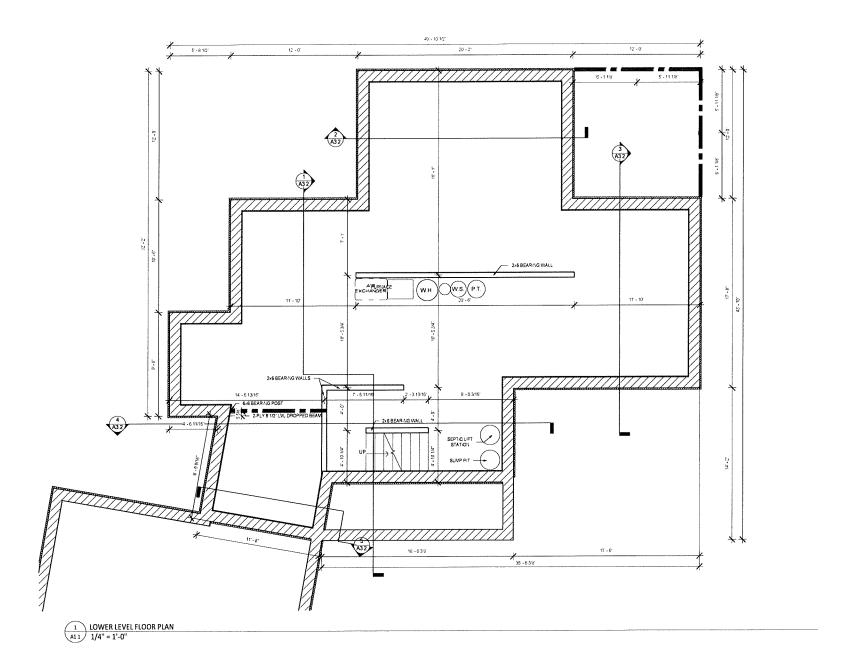



WESHANSON GENERAL CONTRACTORS AND PROFESSIONAL DESIGN


DREWS RESIDENCE DREWS DARRIN & AMANDA 37223 TWIN BAY DRIVE CROSSLAKE, MN 56442 LOWER LEVEL FLOOR PLAN

DRAWN BY MMS CHECKED BY: MWS DATE: 8-29-25


A1.1

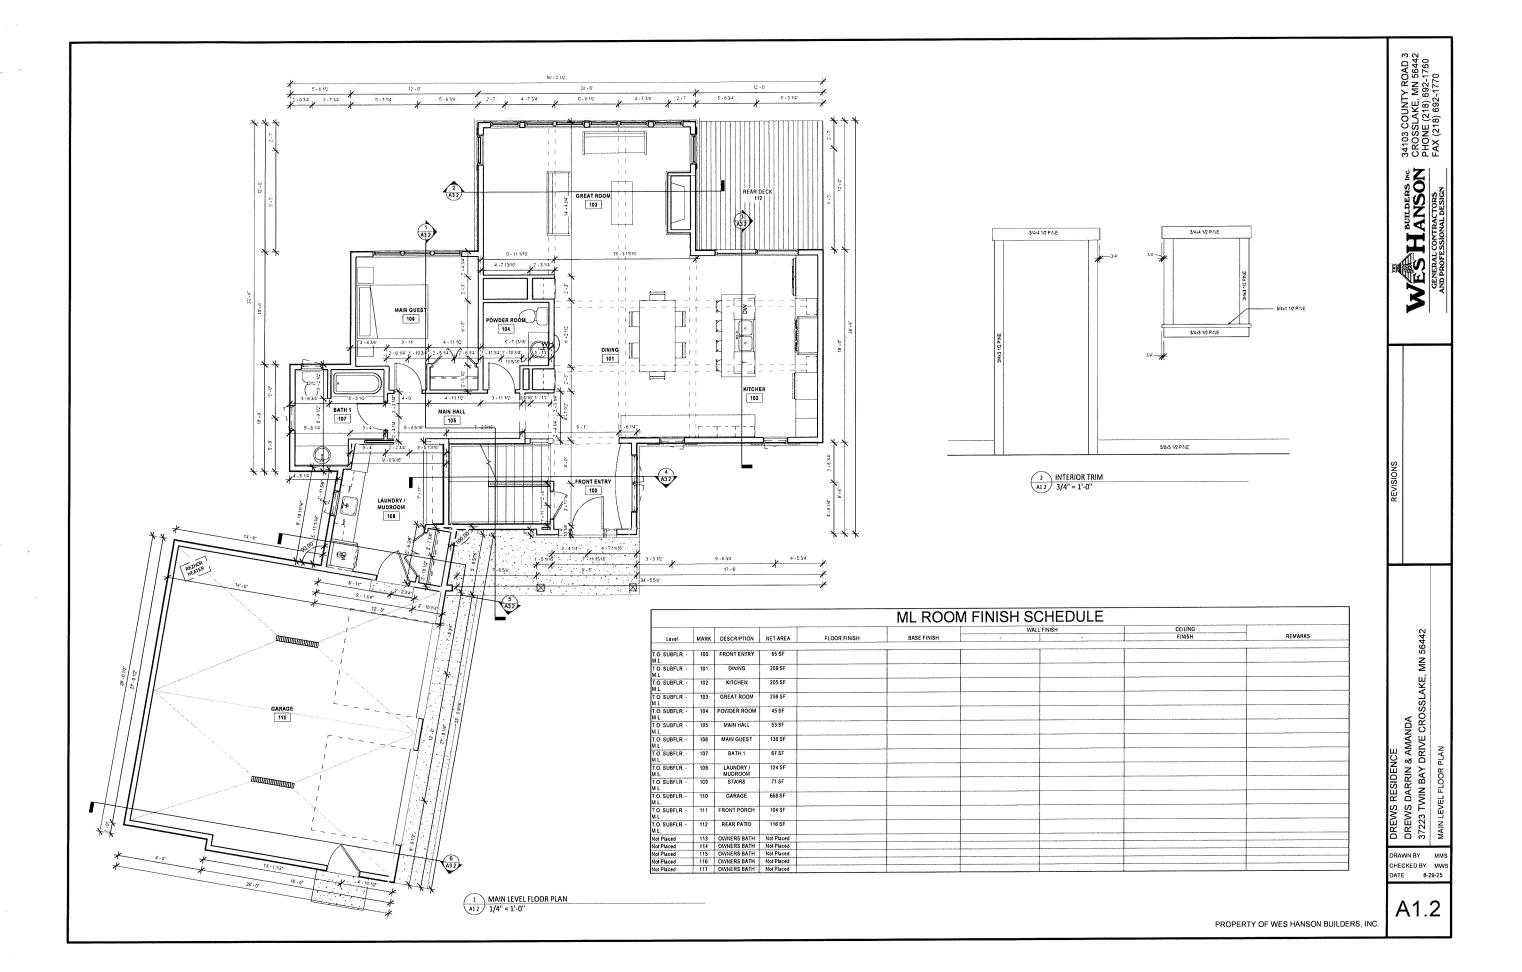


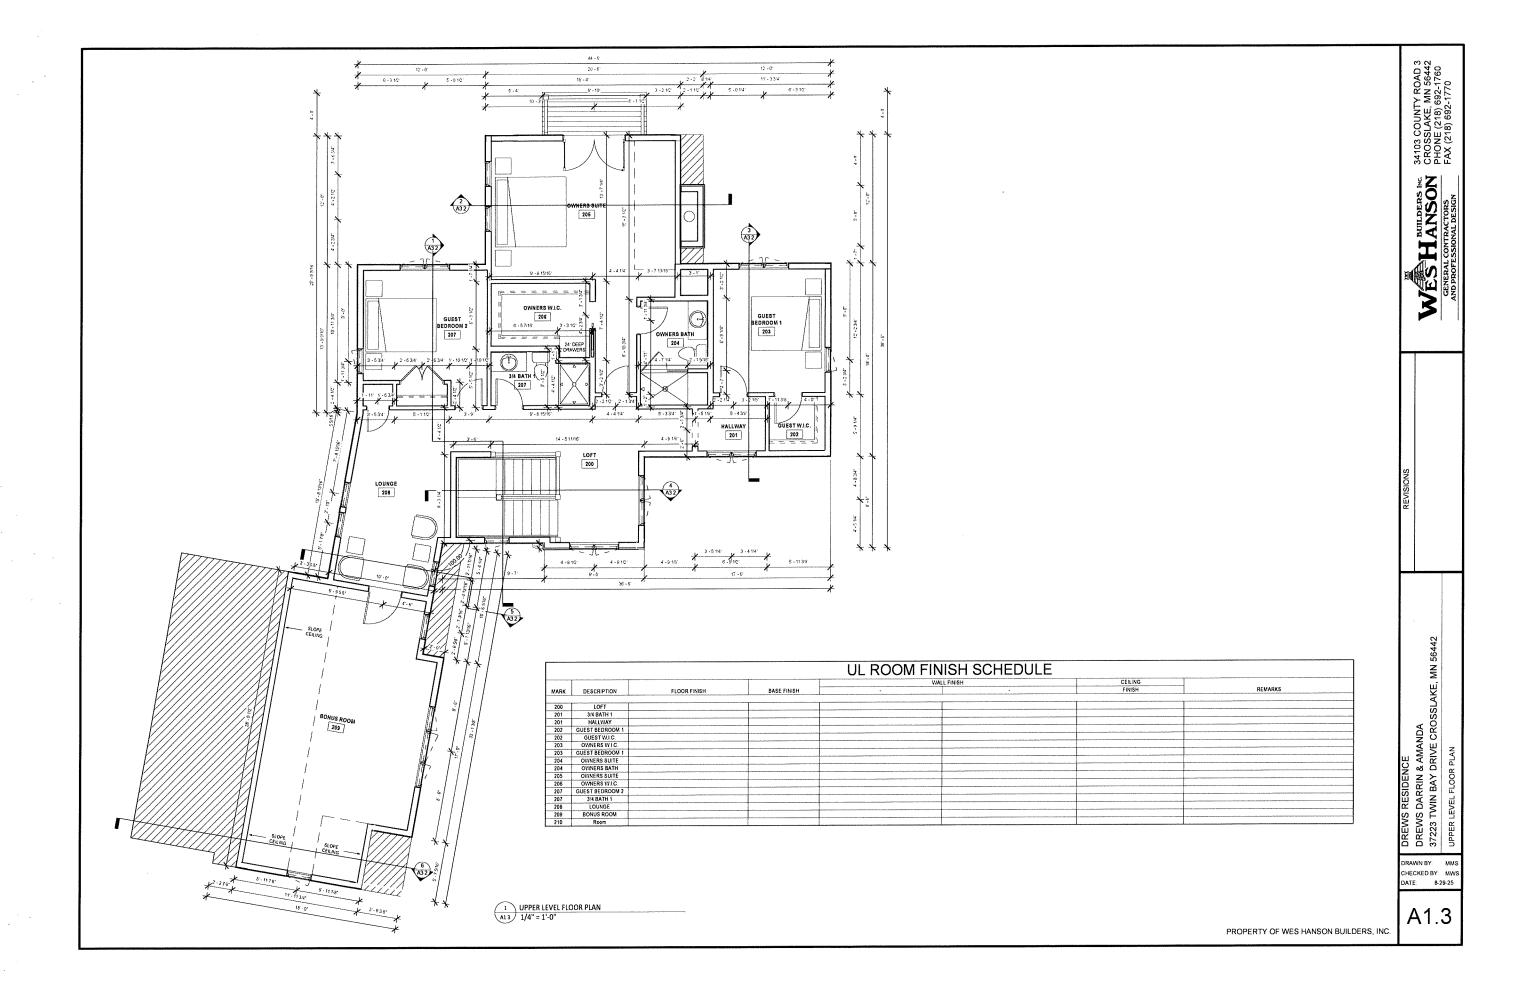


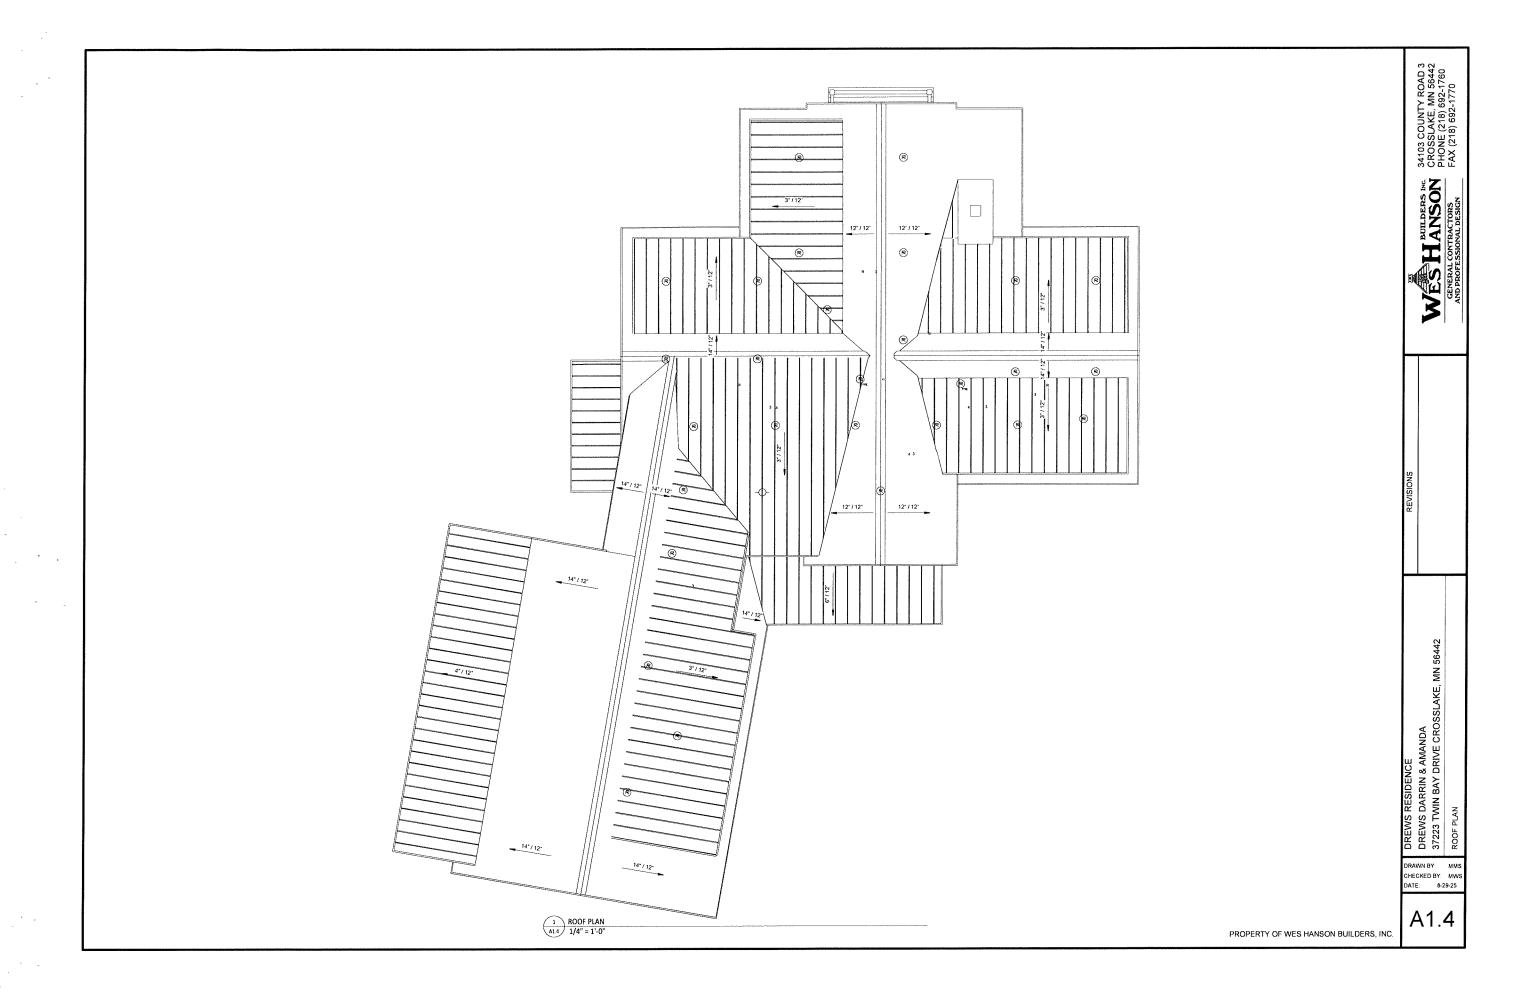




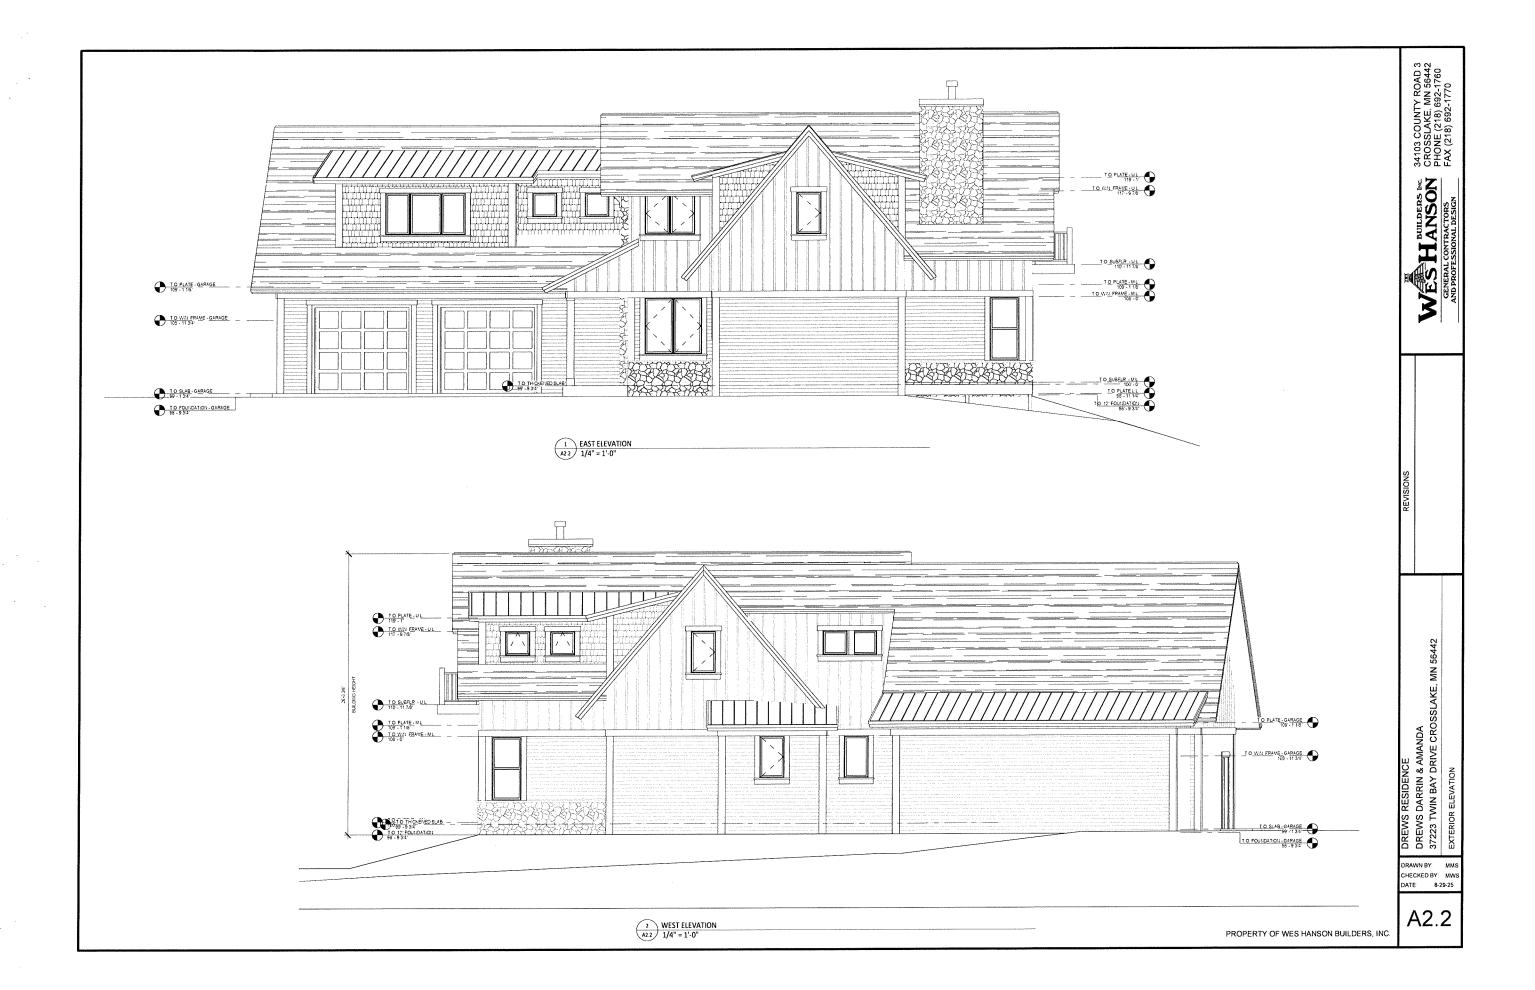

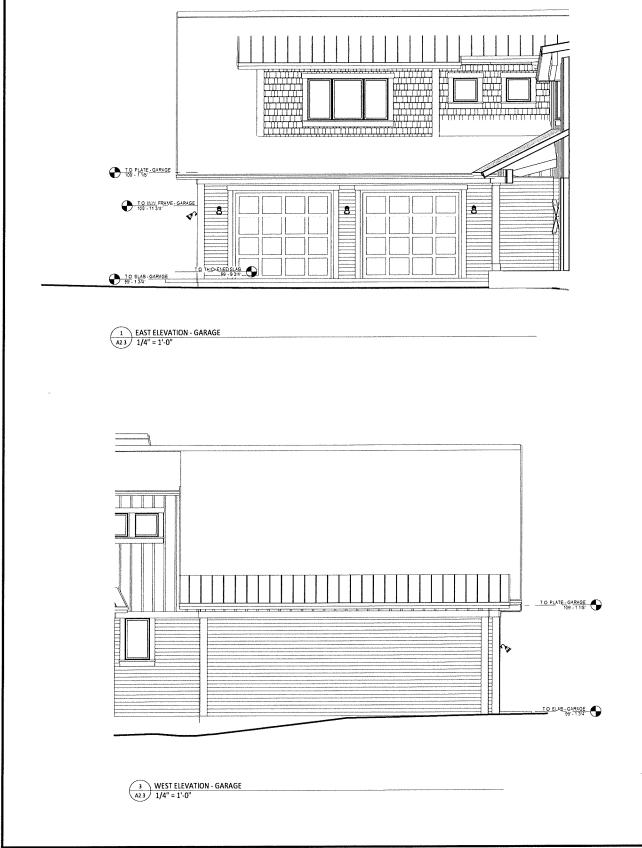

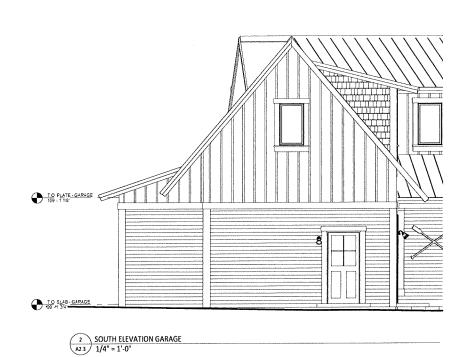

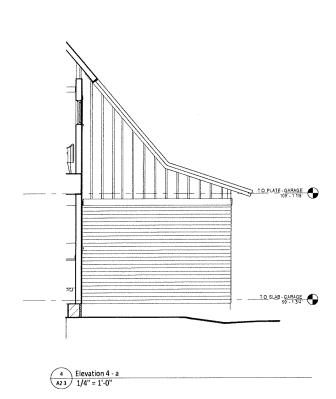


DREWS RESIDENCE
DREWS DARRIN & AMANDA
37223 TWIN BAY DRIVE CROSSLAKE, MN 56442

SW SW SW SW STERIOR ELEVATION


34103 COUNTY ROAD 3 CROSSLAKE, MN 56442 PHONE (218) 692-1760 FAX (218) 692-1770

WESHANSON GENERAL CONTRACTORS
AND PROFESSIONAL DESIGN

A2.3

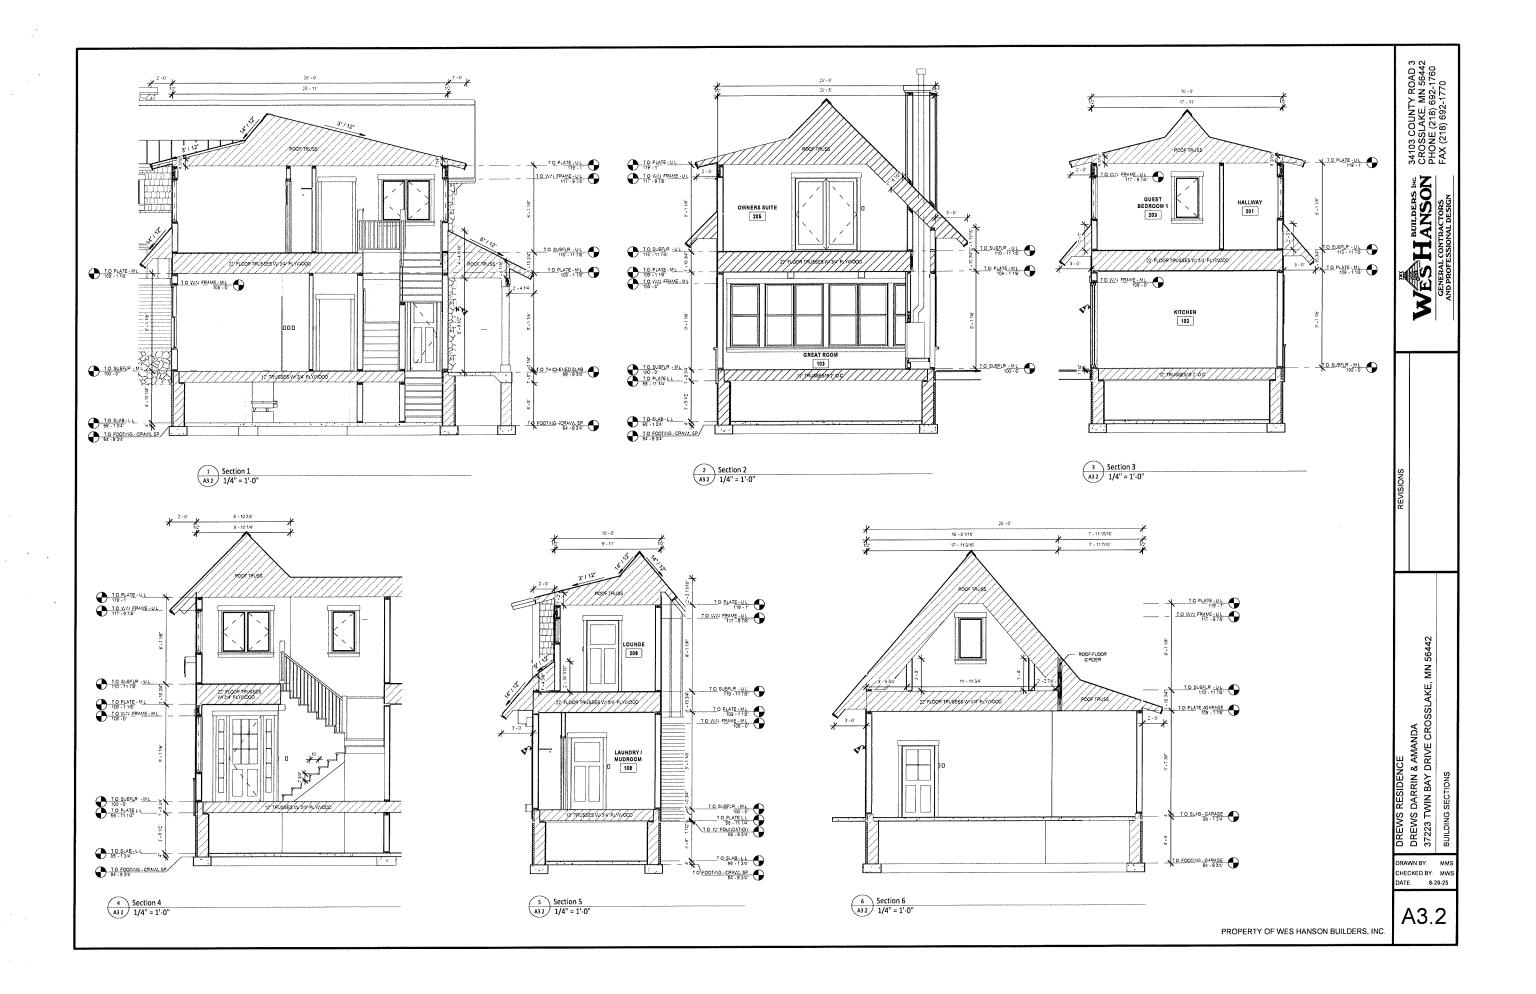



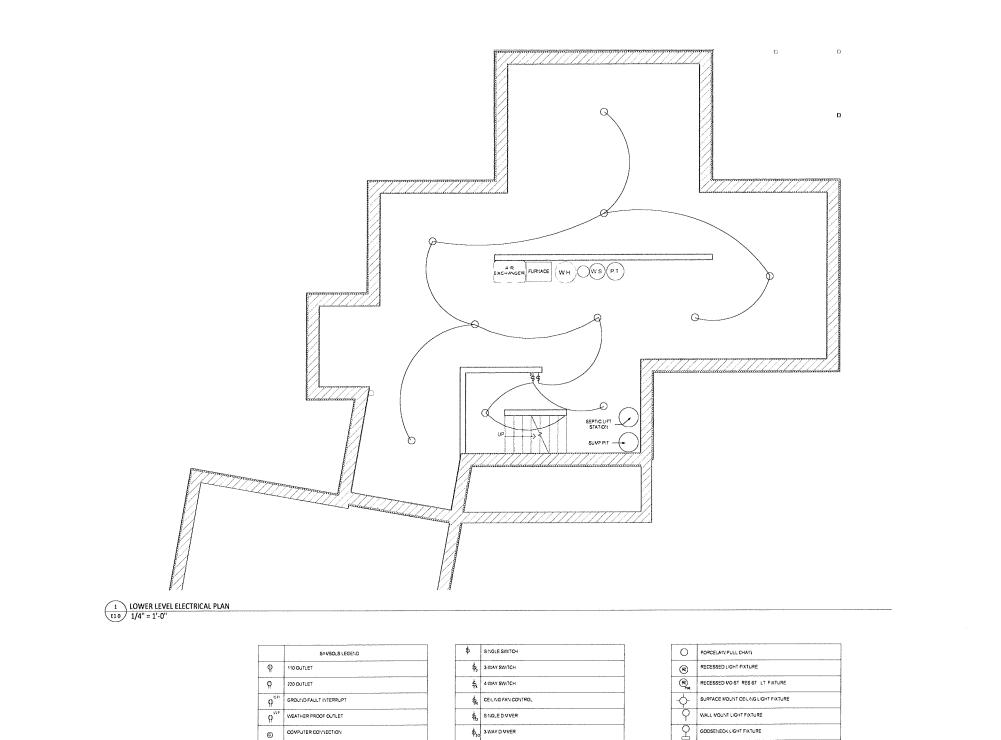

CHANDELIER LIGHT FIXTURE RECESSED WALL LIGHT CELLING FAN WITH LIGHT ALL HEIGHTS ARE TO TOP OF JUNCTION BOX. VERIFY WI ARCHITECT PRIOR TO INSTALLATION

PLUMBING:
1.) HOT WATER RECIRCULATION (OPTION)
2.) SINKS
- UNDERMOUNT (GRANITE)
- INTEGRATED (C. MARBLE)
- DROP-IN (LAMINATE)
- FAUCETS / FIXTURES = ? FINISH
3.) SHOWERS
- TILE = MASTER
- TUB/SHOWER INSERT = LL + U.L. BATH

4.) HOSE BIB
- FROST FREE,
- LOCATION - SEE PLAN
5.) WATER HEATER
- 80 GALLON HIGH EFFICIENCY (NAT. GAS)

- TANKLESS 6.) WATER SOFTENER - TBD

7.) SEPTIC SYSTEM
- GRAVITY TO LOWER LIFT TO TANK / FIELD

HVAC:
1.) FORCED AIR
- 95% EFFICIENCY (NAT. GAS)
2.) THERMOSTATS
- 3 ZONE - ELECTRONIC, WI-FI CAPABLE
LOCATION = LOWER, UPPER, MAIN
3.) HANGING UNIT HEAT
- MANUAL STAT. - (OPTION)
4.) AIR CONDITIONING - YES
5.) AIR EXCHANGER - YES
5.) GAS - NATURAL, LP, ELECTRIC

34103 COUNTY ROAD 3 CROSSLAKE, MN 56442 PHONE (218) 692-1760 FAX (218) 692-1770

DREWS RESIDENCE DREWS DARRIN & AMANDA 37223 TWIN BAY DRIVE CROSSLAKE, MN 58442

DRAWN BY: CHECKED BY: MWS DATE: 8-29-25

E1.0

\$ TIVER SWITCH SYSTEM KEYPAD EXHAUST FAN COVB NATION EXHAUST FAN / LIGHT LV INUNDER CABINET LOW VOLTAGE LIGHT

ELECTRICAL LEGEND
1/4" = 1'-0"

SPECIAL OUTLET

FLOOR OUTLET

▼ PHONE JACK


▼ DATAVO CE JACK

☐ TELEVISION JACK

+

CEILING OUTLET

PROPERTY OF WES HANSON BUILDERS, INC.

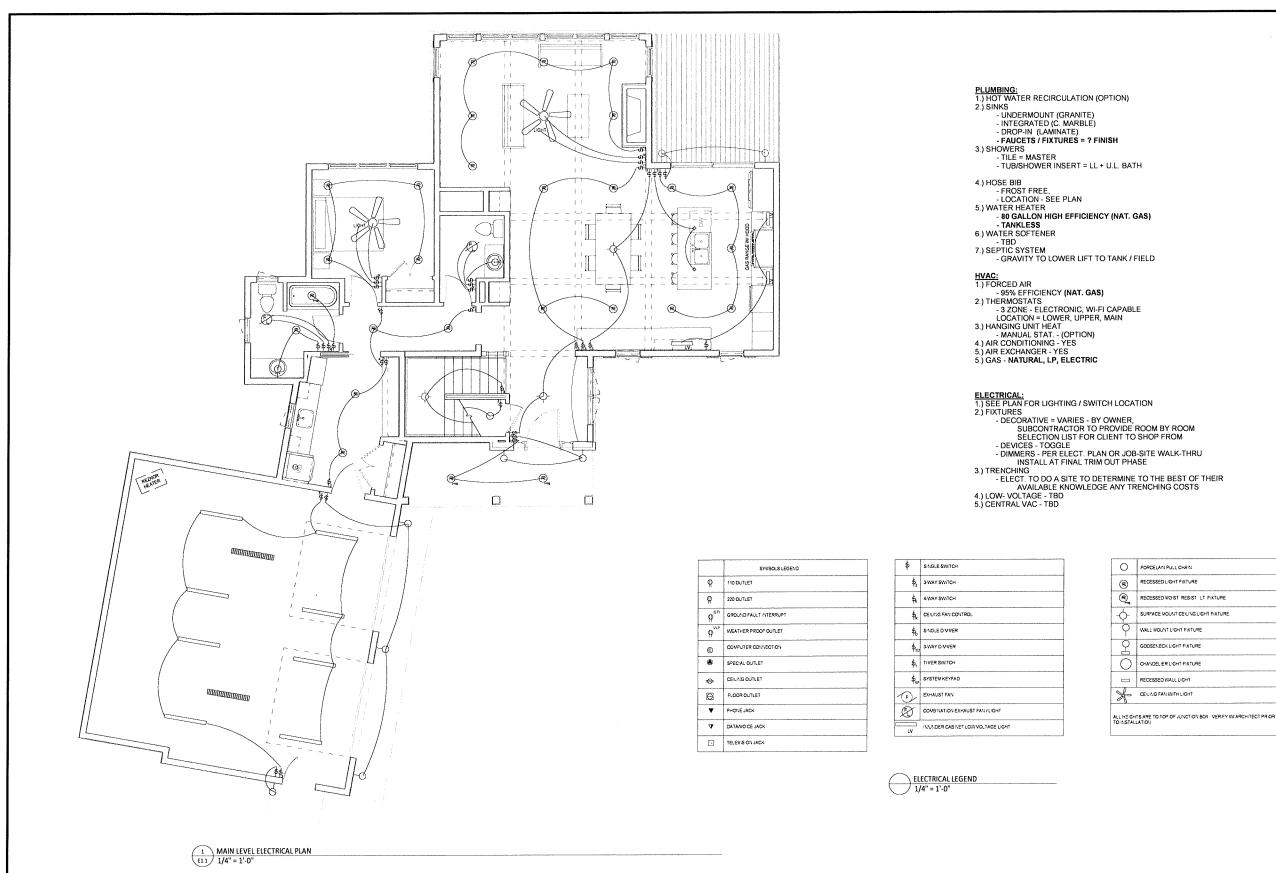


PROPERTY OF WES HANSON BUILDERS, INC.

WES HANSON

DREWS RESIDENCE DREWS DARRIN & AMANDA 37223 TWIN BAY DRIVE CROSSLAKE, MN 56442 MAIN LEVEL ELECTRICAL PLAN

DRAWN BY: MMS CHECKED BY: MWS

DATE: 8-29-25

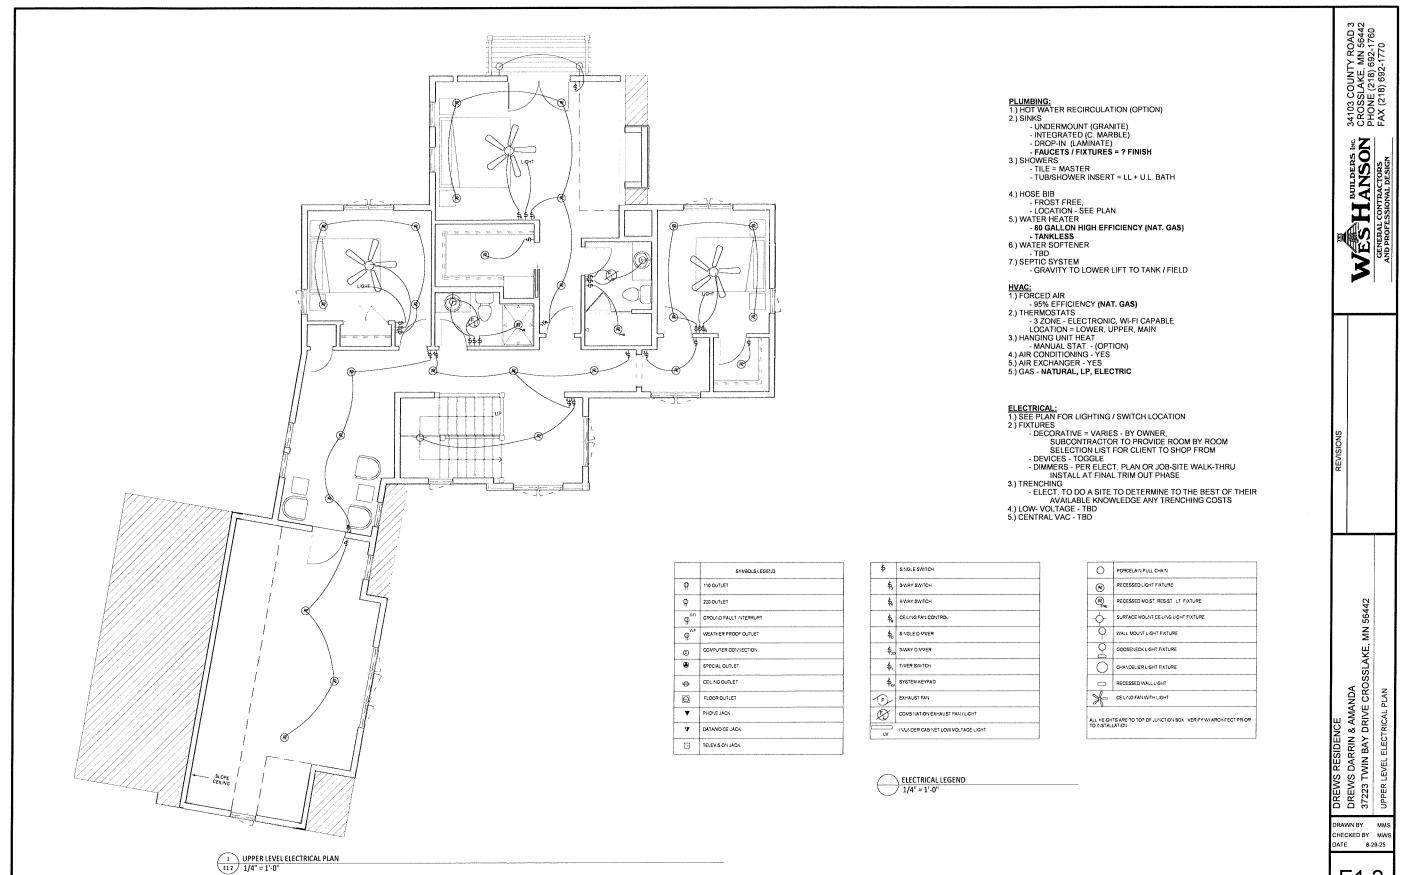

E1.2

PROPERTY OF WES HANSON BUILDERS, INC.



Variance Application
Planning and Zoning Department
13888 Daggett Bay Road, Crosslake, MN 56442
218.692.2689 (Phone) 218.692.2687 (Fax) www.cityofcrosslake.org

Receipt Number: 48 le	Permit Number: 250177
Property Owner(s): DREWS, DARRIN ALAN & AMANDA KAY TRUST Mailing Address: 10525 FENNER AVE SE DELANO MN 55328	<u>Variances</u> (Check applicable requests)
Site Address: 37223 TWIN BAY DR CROSSLAKE MN 56442	Lake/River Setback
Phone Number: 612-968-2049	Road Right-of-Way Setback
E-Mail Address: Amanda @dreusin dustrics.com	☐ Bluff Setback
Parcel Number(s): 14070610	Side Yard Setback
Legal Description: Lot 17 Block 1	☐ Wetland Setback
Sec_07 Twp 137 Rge 26 27 ✓ 28	Septic Tank Setback
Lake/River Name: RUSH LAKE (WHITEFISH)	■ Septic Drainfield Setback
Do you own land adjacent to this parcel(s)? Yes No	☐ Impervious Coverage
If yes list Parcel Number(s)	☐ Accessory Structure
Authorized Agent: Matthew Schmidt/Wes Hanson Builders	☐ Building Height
Agent Address: 34103 COUNTY ROAD 3, CROSSLAKE MN 56442	☐ Patio Size
Agent Phone Number: 218-692-1760	
Signature of Property Owner(s)	Date 9-5-25
Signature of Property Owner(s) Signature of Authorized Agent(s) Wes Hunse	M Bldrs) Date 9-5-25
 All applications must be accompanied by a signed Certificate of Suffice \$750 for Residential and Commercial Payable to "City of Cross No decisions were made on an applicant's request at the DRT meet after DRT does not constitute approval. Approval or denial of apple Planning Commission/Board of Adjustment at a public meeting as City of Crosslake Land Use Ordinance. 	nrvey slake" ting. Submittal of an application lications is determined by the
For Office Use: Application accepted by Date	Land Use District SD
Lake Class Septic: Compliance \$13-25 SSTS Design 9	-4-25 Installation



Practical Difficulty Statement

Pursuant to City of Crosslake Ordinance Article 8 – Variances may be granted when it is found that strict enforcement of the Land Use Ordinance will result in a "practical difficulty".

Please answer the following questions regarding the "practical difficulty" for your variance request.

1.	Is the Variance request in harmony with the purposed and intent of the Ordinance? Yes ■ No□ Why:			
	Defer to the Planning Commission/Board of Adjustment			
2.	Is the Variance consistent with the Comprehensive Plan? Yes ■ No□ Why:			
	Defer to the Planning Commission/Board of Adjustment			
3.	Is the property owner proposing to use the property in a reasonable manner not permitted by the Land Use Ordinance? Yes ■ No□ Why:			
	The size and shape of the property leaves a smallish, oddly shaped building envelope. This has left them with non-conformities with			
	little to no option for solution. As such, the proposal intends to create a viable structure that decreases the current non-conformities that			
	are directly caused by the nature of the property.			
4.	Will the issuance of a Variance maintain the essential character of the locality? Yes ■ No□ Why:			
	There are similar structures up and down the shoreline / road in this area. Our proposal would not be noticably different than multiple			
	structures within the neighborhood.			
5.	Is the need for a Variance due to circumstances unique to the property and not created by the property owner?			
	Yes ■ No □			
	Why:			
	The lot size, shape and road right of way have created the circumstances we are trying to work within.			
6.	Does the need for a Variance involve more than economic considerations? Yes ■ No □ Why:			
	To do anything within the property / building envelope would require a variance of some kind. Our proposal seeks to do so in the least			
	invasive way possible while also decreasing multiple non-conformities currently present on the property.			



City of Crosslake Planning Commission/Board of Adjustment

FINDINGS OF FACT SUPPORTING / DENYING A VARIANCE REQUEST

A Variance may be granted by the Planning Commission/Board of Adjustment when it is found that strict enforcement of the Land Use Ordinance will result in a "practical difficulty" according to Minnesota Statute Chapter 462. The Planning Commission/Board of Adjustment should weigh each of the following questions to determine if the applicant has established that there are "practical difficulties" in complying with regulations and standards set forth in the Land Use Ordinance.

there are "praction Land Use Ordina	cal difficulties" in complying with regulations and standards set forth in the nce.
1. Is the Variance Yes Why:	re request in harmony with the purposes and intent of the Ordinance? No
2. Is the Variance Yes Why:	e consistent with the Comprehensive Plan? No
3. Is the property the Land Use Yes Why:	y owner proposing to use the property in a reasonable manner not permitted by Ordinance? No

4.		iance of a Varia No	nce maintain th	e essential chara	acter of the locality	₇ ?
	Is the need e property ov Yes Why?		due to circumst	ances unique to	the property and r	not created by
6.		ed for a Varian No	ce involve more	than economic	considerations?	