City Hall: 218-692-2688

Planning & Zoning: 218-692-2689

Fax: 218-692-2687



13888 Daggett Bay Rd Crosslake, Minnesota 56442 www.cityofcrosslake.org

CITY OF CROSSLAKE PLANNING COMMISSION/BOARD OF ADJUSTMENT

May 26, 2023

9:00 A.M.

Crosslake City Hall 13888 Daggett Bay Rd, Crosslake MN 56442 (218) 692-2689

PUBLIC HEARING NOTICE

Applicant: Underwood Real Estate LLC

Authorized Agent: Paul Skogen of Hy Tech Construction

Site Location: 12292 Manhattan Pt Blvd, Crosslake, MN 56442 on Big Trout - GD

Variance for:

- Bluff setback of 0 feet (ft) where 30 ft is required to proposed dwelling
- Bluff setback of 0 f where 30 ft is required to proposed patio
- Bluff impact zone encroachment of 12 feet +/- where none is allowed for a proposed patio
- Dirt moving in the bluff impact zone, where Chapter 26 states dirt moving in a bluff impact zone is prohibited, except for the placement of stairways, lifts, or landings permitted under Section 26-313, for a proposed patio
- Dirt moving in the bluff setback zone, where Chapter 26 states dirt moving in a bluff impact zone is prohibited, except for the placement of stairways, lifts, or landings permitted under Section 26-313, for a proposed dwelling and patio

To construct and allow:

- 2,451 sf dwelling where 1,299 sf are within the bluff setback
- 1,726 sf patio where 748 sf are within the bluff impact zone & 978 sf are within the bluff setback
- Dirt moving of 425 cy consisting of 100 cy in the bluff impact zone & 325 cy in the bluff setback for a proposed dwelling & patio

Notification: Pursuant to Minnesota Statutes Chapter 462, and the City of Crosslake Zoning Ordinance, you are hereby notified of a public hearing before the City of Crosslake Planning Commission/Board of Adjustment. Property owners have been notified according to MN State Statute 462 & published in the local newspaper. Please share this notice with any of your neighbors who may not have been notified by mail.

Information: Copies of the application and all maps, diagrams or documents are available at Crosslake City Hall or by contacting the Crosslake Planning & Zoning staff at 218-692-2689. Please submit your comments in writing including your name and mailing address to Crosslake City Hall or (crosslakepz@crosslake.net).

Crosslake

STAFF REPORT

Property Owner/Applicant: Underwood Real Estate LLC

Parcel Number(s): 14060874, 14060875

Application Submitted: April 10, 2023

Action Deadline: June 8, 2023

City 60 Day Extension Letter sent / Deadline: NA / NA

Applicant Extension Received / Request: NA / NA

City Council Date: NA

Authorized Agent: Paul Skogen of Hy Tech Construction

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Current Zoning: Shoreland District

Existing Impervious Coverage:

Proposed Impervious Coverage:

13.2%

24.8%

- A stormwater management plan was submitted with the variance application
- Certificate of Installation is in our file dated 10-14-2022

Parcel History:

- May 1991 Deck and septic system,
- May 2016 After the Fact Variance for water-oriented accessory structure with a zero bluff setback
- July 2016 Land Alteration stairway, walkway, water-oriented accessory structure, retaining wall(s), dirt moving

- December 2021 Land Alteration lift, landing, vegetation removal
- June 2022 30x36 accessory structure with 690 square foot auxiliary living, upgrade septic system
- October 14, 2022 Certificate of Installation

Agencies Notified and Responses Received:

County Highway Dept: N/A DNR: Comment(s) received

City Engineer: N/A

Lake Association: No comment received before packet cutoff date

Crosslake Public Works: N/A

Crosslake Park, Recreation & Library: N/A

Concerned Parties: No comment received before packet cutoff date

POSSIBLE MOTION:

To approve/table/deny the variance to allow:

- Bluff setback of 0 feet (ft) where 30 ft is required to proposed dwelling
- Bluff setback of 0 f where 30 ft is required to proposed patio
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As shown on the certificate of survey dated 4-13-2023



CERTIFICATE OF SURVEY

LOTS 5 AND 6, BLOCK 4, MANHATTAN BEACH (A REPLAT OF TWIN BEACH) SECTION 6, TOWNSHIP 137 NORTH, RANGE 27 WEST, **CROW WING COUNTY, MINNESOTA**

PROPOSED HOUSE HGT. = 22'

1291.17 X

1201.00

1290.84

AREA 2

PERVIOUS (





GENERAL DEVELOPMENT CLASSIFICATION NORMAL RESERVOIR POOL ELEVATION = 1229.57

100 YEAR FLOOD ELEVATION = 1231.00

LOTS 5 & 6 47,176 SQ. FT.± 1.1 ACRES± BUILDABLE AREA = 19,315 SQ. FT. AREA LESS BLUFF 30,990 SQ. FT.

748 SQ. FT. OF PATIO WITHIN BLUFF 978 SQ. FT. OF PATIO WITHIN BLUFF SETBACK 1299 SQ. FT. OF BUILDING WITHIN BLUFF SETBACK

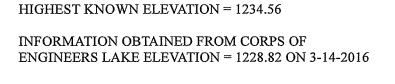

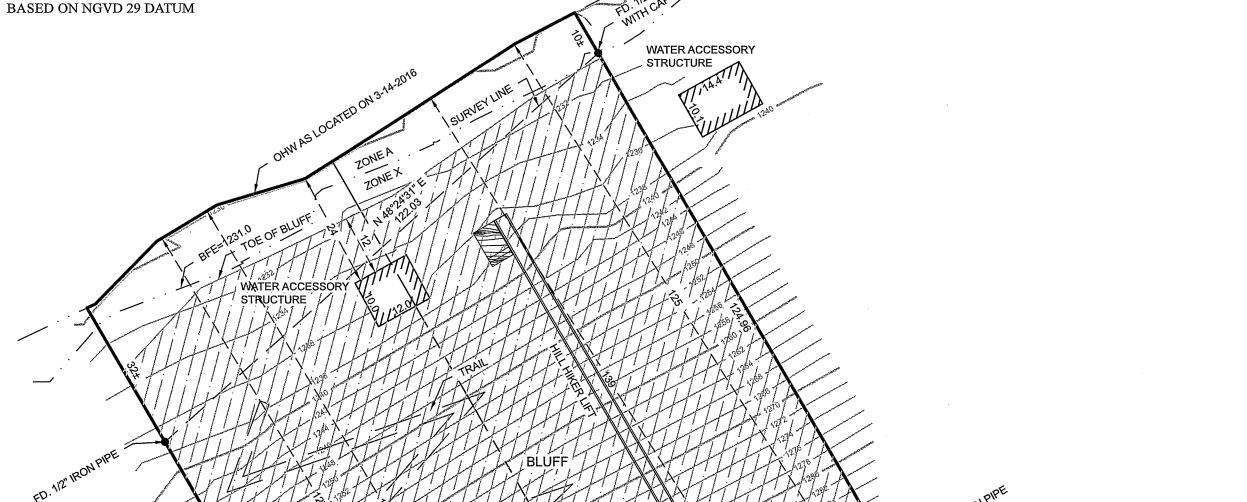

AREA 3

1290.92

×1291.

/ 1290.66 *

IMPERVIOUS CALCULATIONS **EXISTING** Net Area Percent 741 47,176 1.6% House Garage 643 47,176 1.4% Water Accessory Structure 120 47,176 0.3% Concrete & Pavers 650 47,176 1.4% 8.6% Bituminous 4,056 47,176 13.2% 6,210 47,176

IMPERVIOUS CALCULATIONS **PROPOSED** Percent Net Area Water Accessory Structure 120 0.3% 47,176 1,056 47,176 2.2% 2,086 47,176 4.4% Proposed Patios & Concrete Exist. & Proposed Bituminous 4,818 10.2% 47,176 5.2% 2,451 47,176 Proposed House Proposed Attached Garage 2.5% 1,174 47,176 11,705 47,176 24.8% Total

RUN OFF CALCULATIONS Total Impervious Surface Area 11,705 sq. ft. x 0.0833 ft. = 975 cu. ft.

LEGEND

— X — X — DENOTES EXISTING FENCE LINE

DENOTES EXISTING RETAINING DENOTES EDGE OF EXISTING BITUMINOUS DENOTES EDGE OF EXISTING

CONCRETE DENOTES EDGE OF EXISTING PAVING STONES

DENOTES PROPOSED PATIOS

DENOTES EDGE OF EXISTING DENOTES BLUFF AREA

DENOTES EXISTING INTERMEDIATE CONTOURS DENOTES EXISTING INDEX CONTOURS

DENOTES SPOT ELEVATION ×1234.5 DENOTES EXISTING UTILITY

DENOTES EXISTING ELECTRIC

DENOTES EXISTING GROUND

DENOTES EXISTING PHONE PEDESTAL & PHONE BOX

DENOTES EXISTING WELL DENOTES EXISTING SEPTIC VENT, SEPTIC CLEANOUT, & SEPTIC TANK LID

SEWER CATCH BASIN TO BE REMOVED


BENCHMARK: HIGH POINT OF WELL ELEV. = 1292.54 BASED ON NGVD 29 DATUM

ORIENTATION OF THIS BEARING SYSTEM IS BASED ON THE COMMON LINE OF LOTS 6 & 7 TO HAVE AN ASSUMED BEARING OF N 30°06'08" W.

DENOTES MONUMENT FOUND

NOTES:

- 1. Contour interval as shown = 2 foot. Based on NGVD 29 datum. Contours shown have been obtained using standard survey topographic methodologies. Field located on 3-14-2016.
- 2. Zoning for subject tract = "Shoreland District".
- 3. No wetlands were found on November 16, 2022 at the site per Ben Meister, Meister Environmental, LLC. MN Certified Wetland Delineator #1031.
- 4. Property is in "Zone X" and "Zone A" as per the FIRM, Flood Insurance Rate Map. "Zone A" definition: Areas of 100-year flood base elevations and flood hazard factors not determined. "Zone X" definition: Areas of minimal flooding.
- 5. Parcel IDs of subject parcel: 14060875 & 14060874. 6. The E911 address of subject parcel: 12292 Manhattan Point Blvd..
- 7. Setbacks as shown can be subject to interpretation. Verification of setbacks by the
- governing body is advised prior to building. 8. Approximate location of proposed septic system per sketch prepared by Amy Wannebo.
- 9. Adjoining properties are zoned Shoreland District.

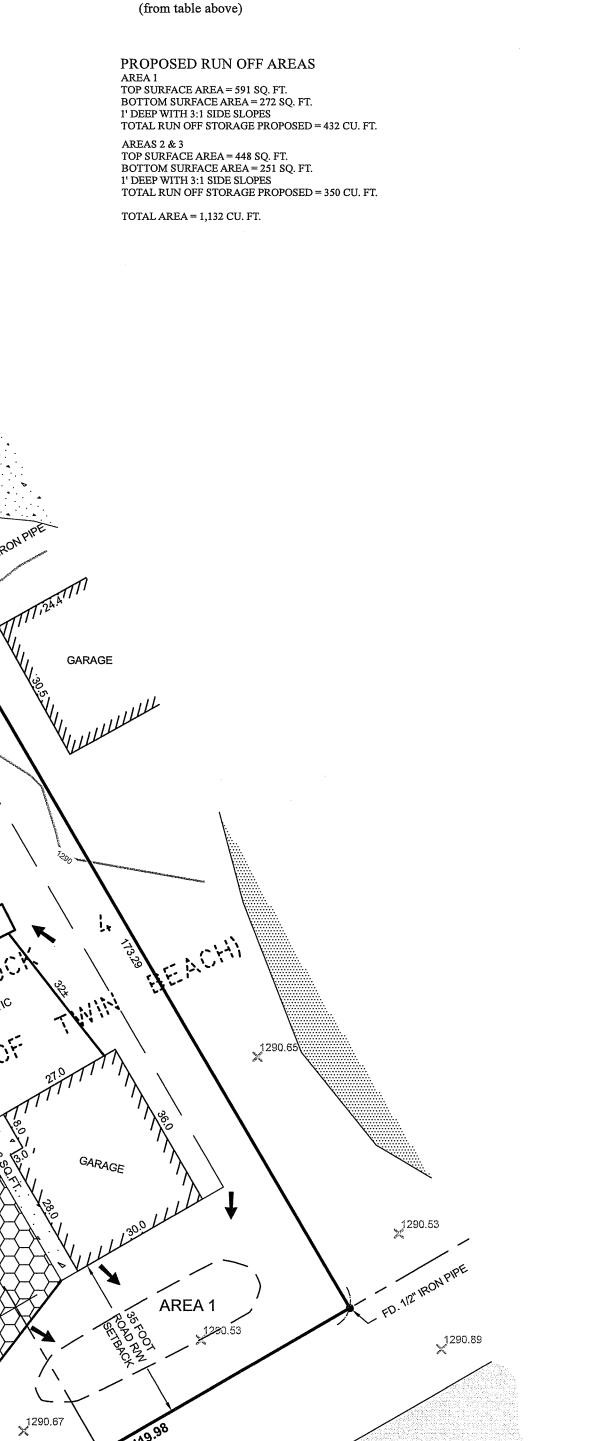

×1290.58

I HEREBY CERTIFY THAT THIS SURVEY, PLAN, SPECIFICATION, OR REPORT WAS PREPARED BY ME OR UNDER MY DIRECT SUPERVISION AND THAT I AM A DULY LICENSED PROFESSIONAL ENGINEER OR LAND PROJECT MANAGER: PROJECT No.: DATE: REVISIONS CERTIFICATE OF SURVEY DESCRIPTION DATE CMH 22108-1 11-18-2022 RJF -29-2022 Added lift and platforms CHECKED FILE NAME: SCALE: URVEYOR UNDER THE LAWS OF THE STATE OF MINNESOTA. Jeff Hanson 3-29-2023 Add Sq.Ft. of pavers & drainage catch basins CMH BY: CMH ynthia m Hidde Hy-Tec Construction HORZ. 1"=20' Calc22108.dwg СМН Add more detail for stormwater P.O. Box 621 DRAWN BY: FIELD BOOK: CYNTHIA M. HIDDE PLS#44881 СМН 4-13-2023 Revised note Brainerd, MN 56401 4/13/2023 LIC. NO. 44881 VERT. NONE RJF BOOK




SCALE IN FEET

ON 22" x 34" SHEET

30206 Rasmussen Road P. O. Box 874 Pequot Lakes, MN 56472 218-568-4940 www.stonemarksurvey.com

CERTIFICATE OF SURVEY


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CROW WING COUNTY, MINNESOTA

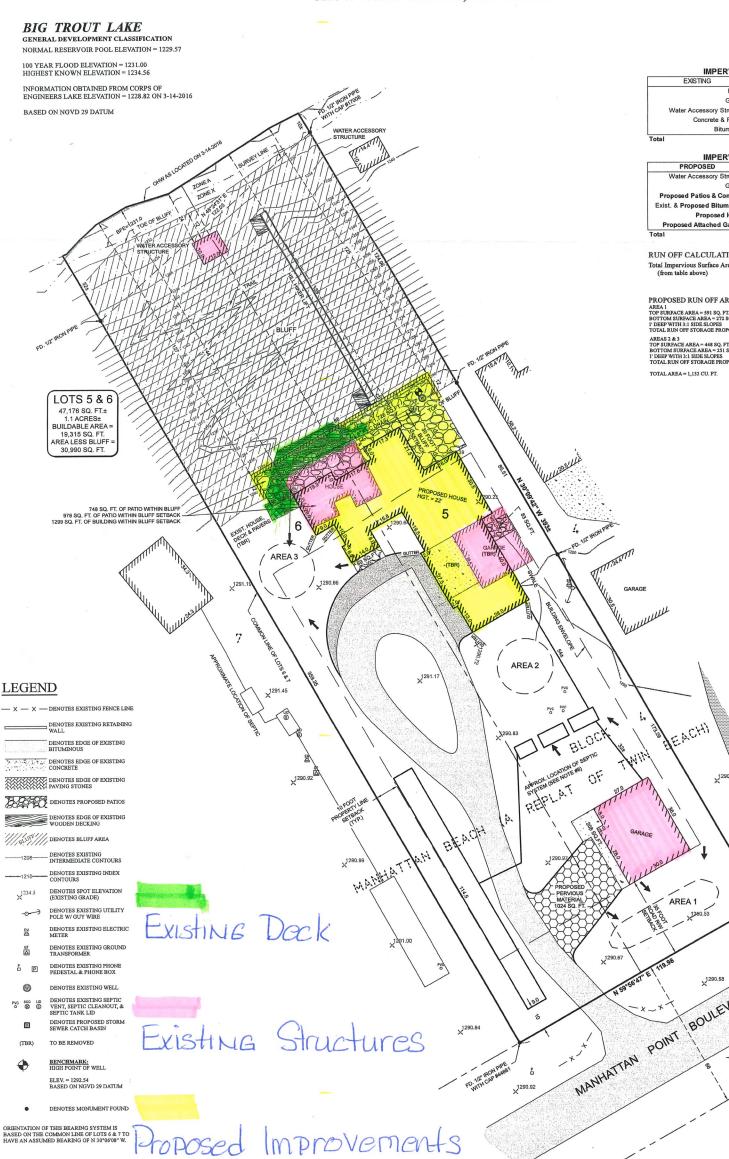








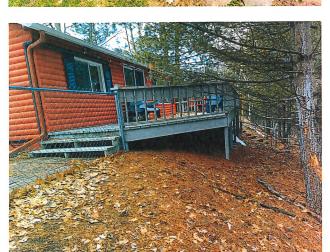



TIMBERS PROVIDED BY BLUE OX TIMBER FRAMES
RAISING/ INSTALLATION OF TIMBERS AS SPECIFIED IN BLUE OX TIMBER FRAMES CONTRACT, DOES NOT
INCLUDE BRACKETS, CORBELS, AND EXTERIOR DECORATIVE TRUSSES, THOSE ARE INSTALLED BY OTHERS
INSTALLATION OF THE T&G FOR VAULTED TIMBER FRAME CEILINGS (INTERIOR ONLY) IF ABLE TO INSTALL
PRIOR TO SETTING SIPS, T&G INSTALLED DIRECTLY TO SIPS WILL BE INSTALLED BY OTHERS

ALLAN & DIAN

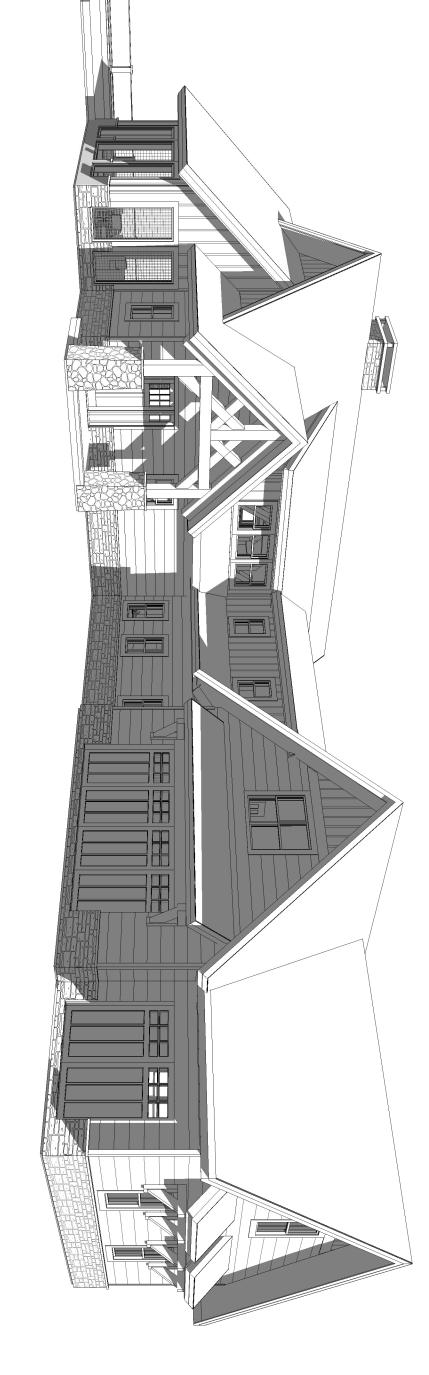


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	EXTERIOR DOOR SO	HEDULE	E- BRAND	EXTERIOR DOOR SCHEDULE - BRAND AND R.O.S TO BE VERIFIED PRIOR TO CONST.
MARK	ROOM	WIDTH	WIDTH HEIGHT	COMMENTS
			2	
_	FOYER	3' - 0"	8' - 0"	16" SIDELIGHTS
2	MUD ROOM	3' - 0"	6' - 8"	20" MIN. FIRE DOOR
ω	MASTER	3' - 0"	7' - 0"	FULL GLASS
4	DINING	3' - 0"	7' - 0"	FULL GLASS
5	DINING	3' - 0"	7' - 0"	FULL GLASS
6	GREAT RM TO DECK 3' - 0"		8' - 0"	FULL GLASS
7	SCREEN PORCH	3' - 0"	8' - 0"	SCREEN DOOR
8	GARAGE	18' - 0" 8' - 0"	8' - 0"	OVERHEAD DOOR
9	GARAGE	9' - 0"	8' - 0"	OVERHEAD DOOR
10	GARAGE	3'-0" 6'-8"		HALF GLASS

BLUE OX TIMBER FRAMES



HOME DESIGN	WOODLAND		\ \ /	>

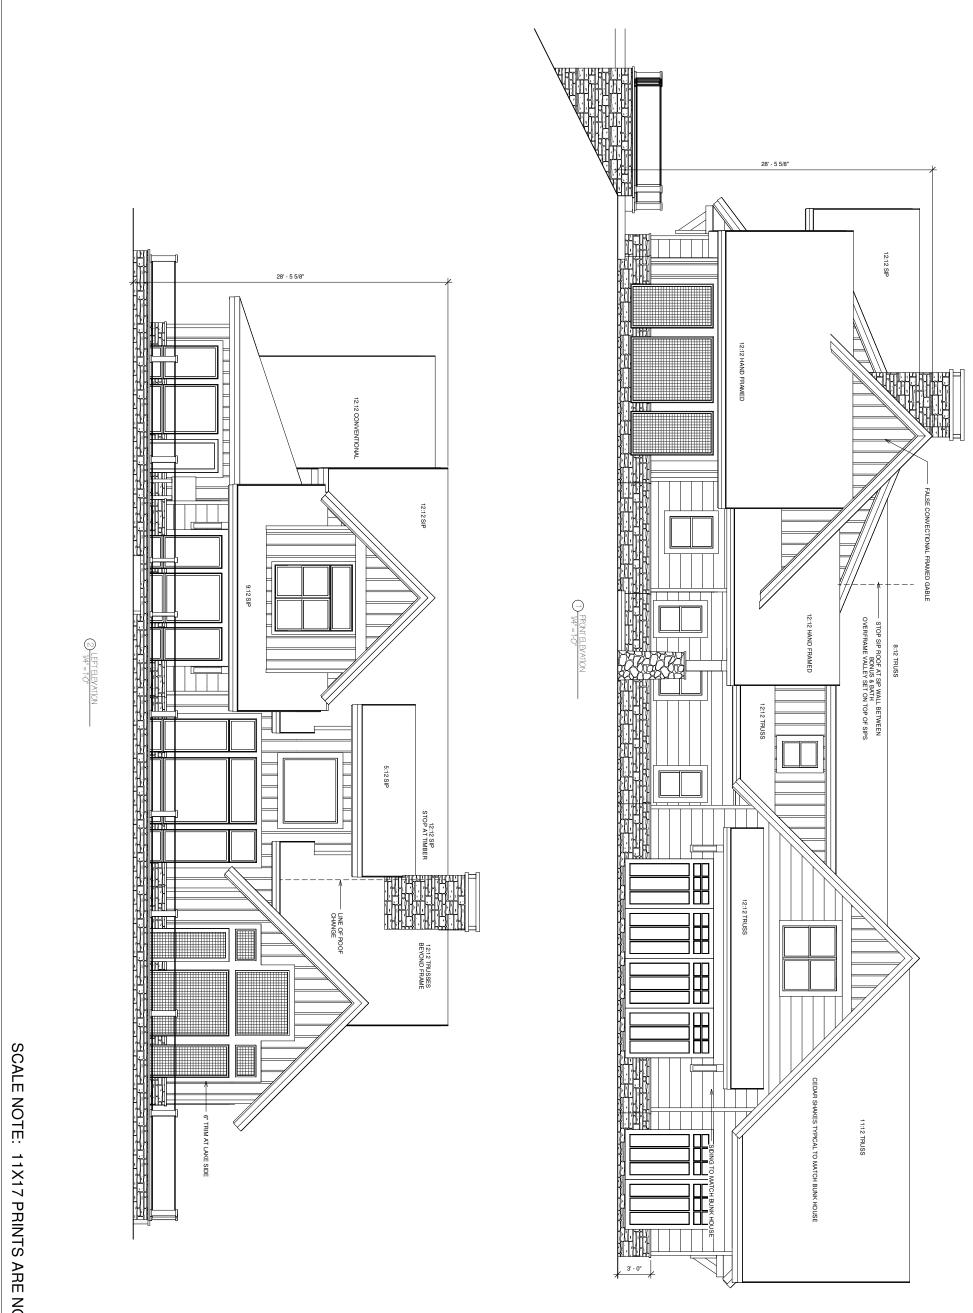

SCALE NOTE: 11X17 PRINTS ARE NOT TO SCALE


ELEVATIONS A-1.1

REVISED 8/23/18 REVISED: 7/31/20 1/5/22 9/19/22 DRAWN BY KG WOODLAND HOME DESIGN 3/3/22 8/7/18 2/8/23

ALLAN & DIANE CRONEN BLUE OX TIMBER FRAME Enter address here

BLUE OX TIMBER FRAMES

HOME DESIGN
PO Box 847,
Alexandria, MN
320-815-3143
Copyright 2014 - Current
Disclaimer Of
Warranties

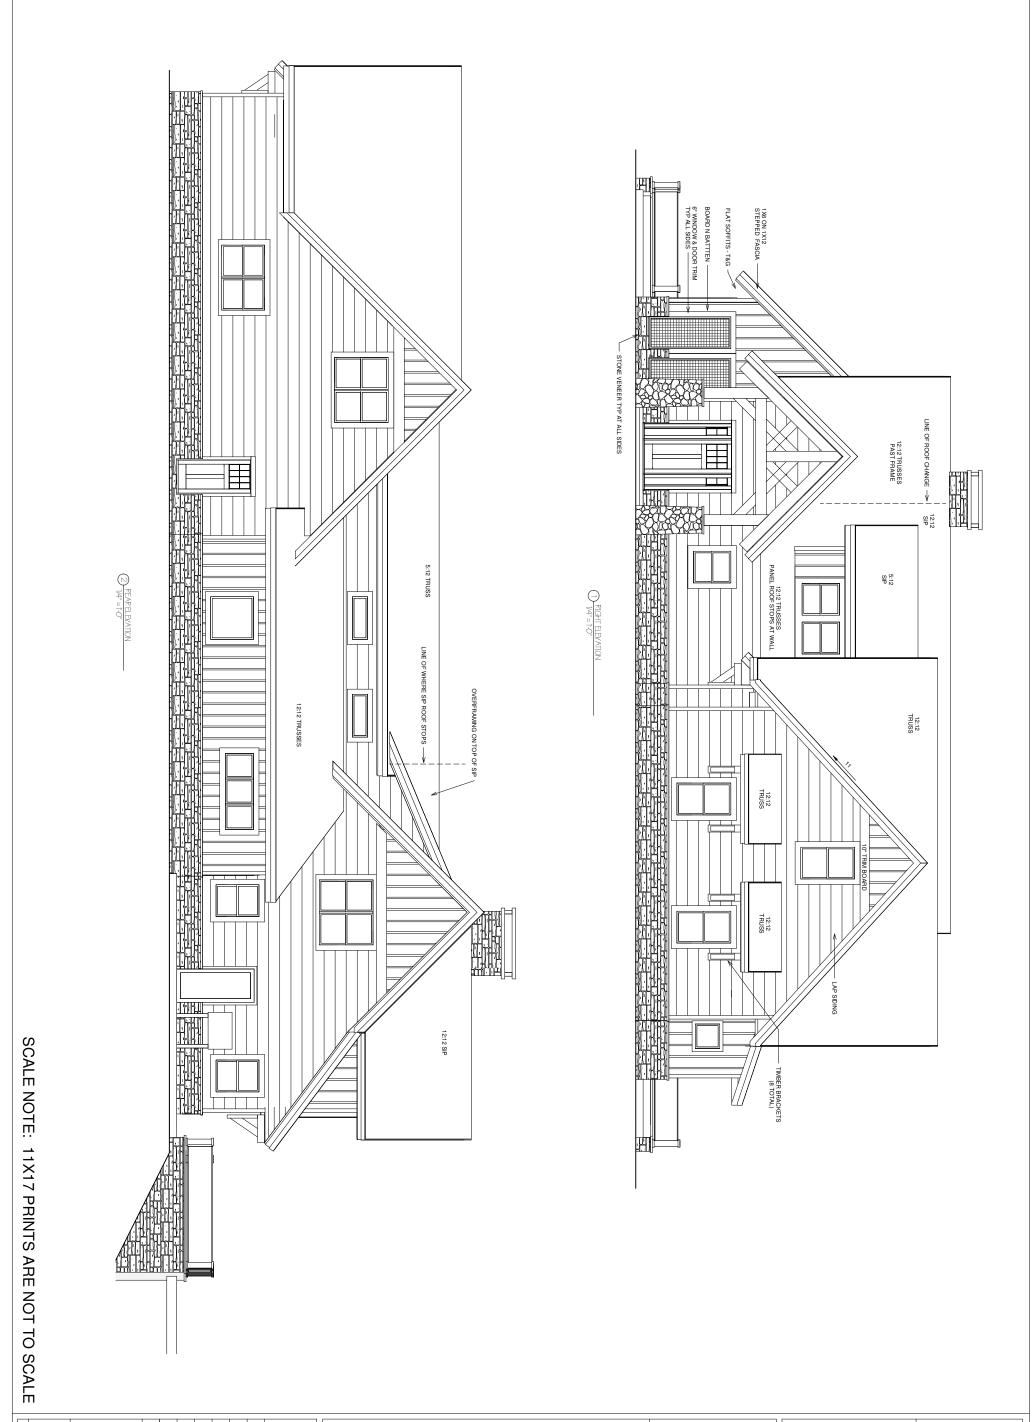

A-1.2

ELEVATIONS


8/23/18 REVISED: 7/31/20 9/19/22 1/5/22 DRAWN BY KG WOODLAND HOME DESIGN 3/3/22 8/7/18 2/8/23

ALLAN & DIANE CRONEN Enter address here

BLUE OX TIMBER FRAME



HOME DESIGN HOME D

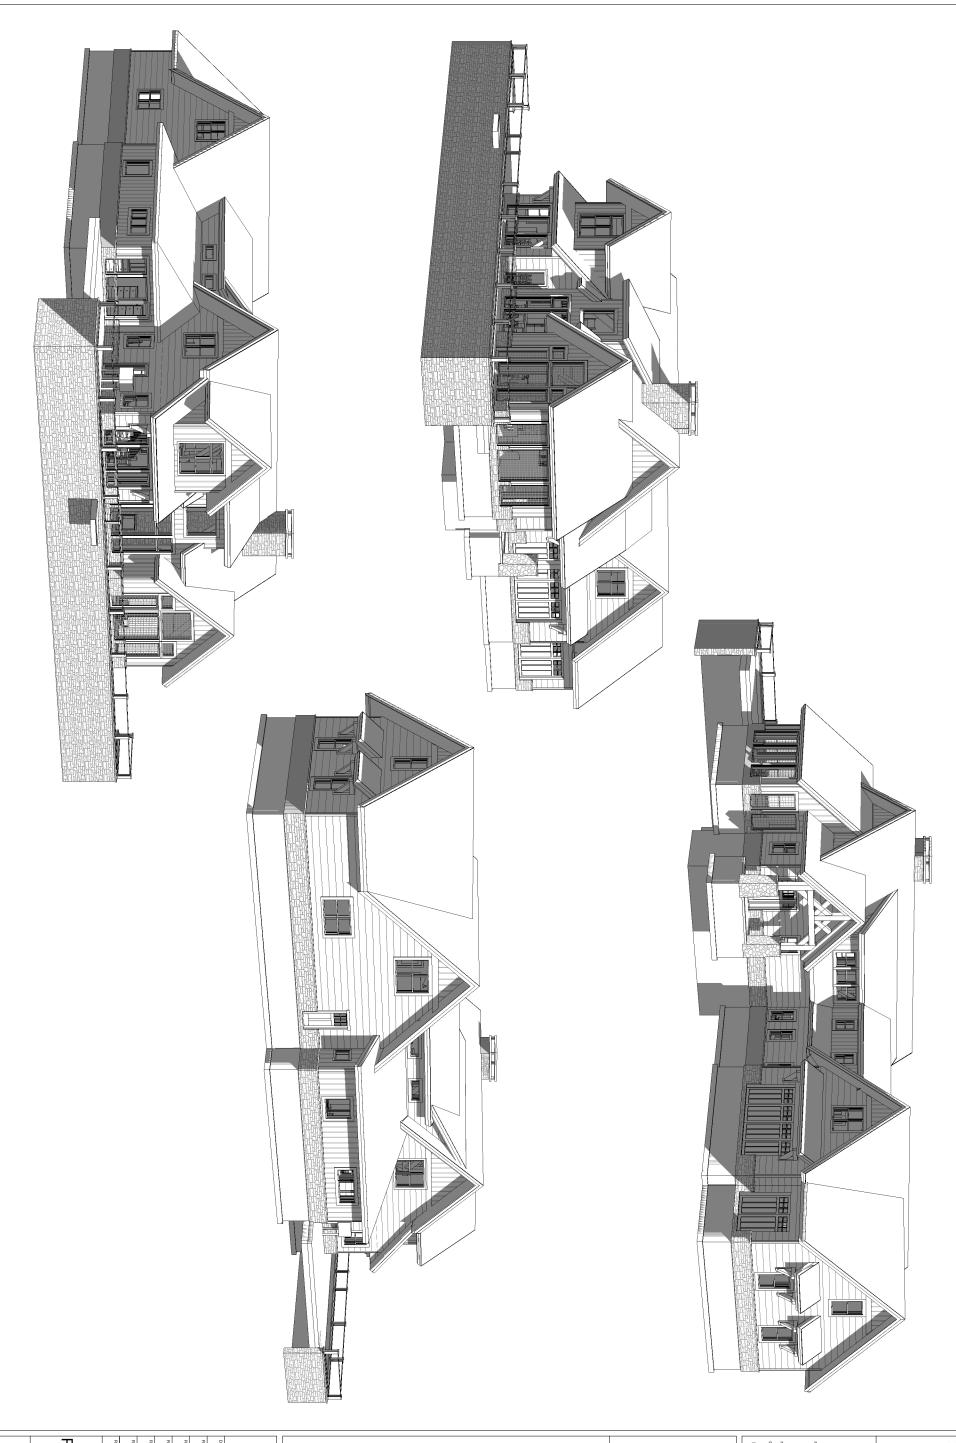

A-1.3

PERSPECTIVE ELEVATIONS


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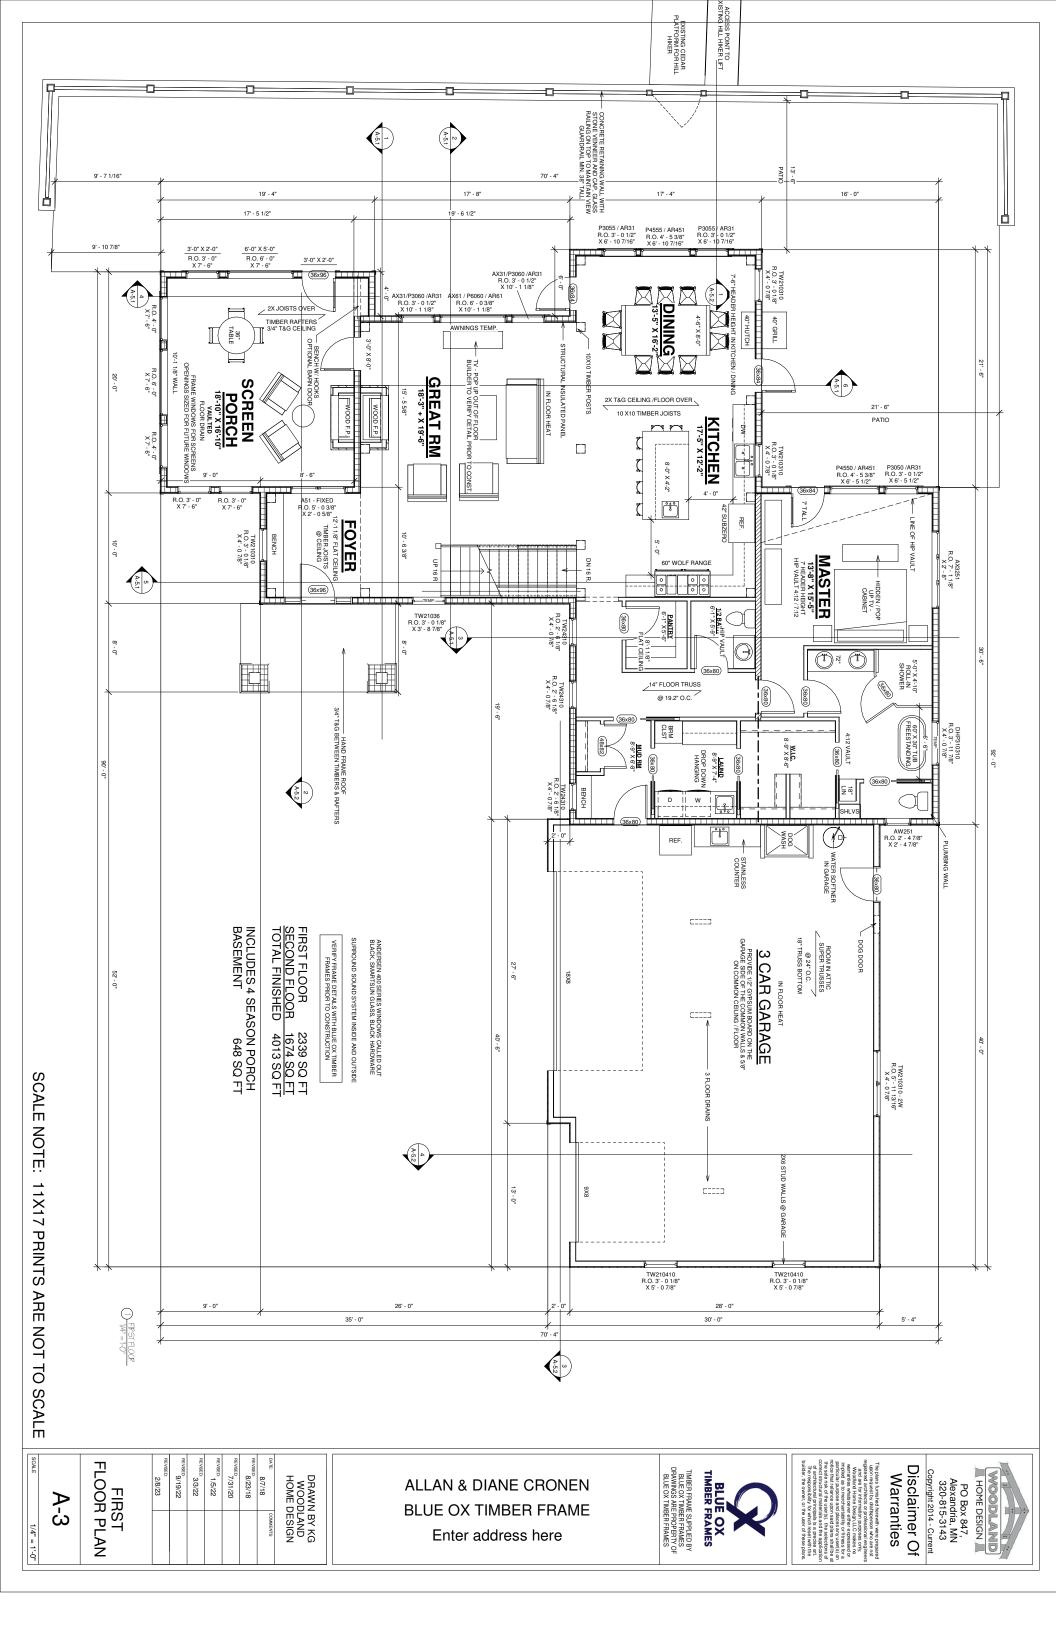
BLUE OX TIMBER FRAME


ALLAN & DIANE CRONEN Enter address here



HOME DESIGN
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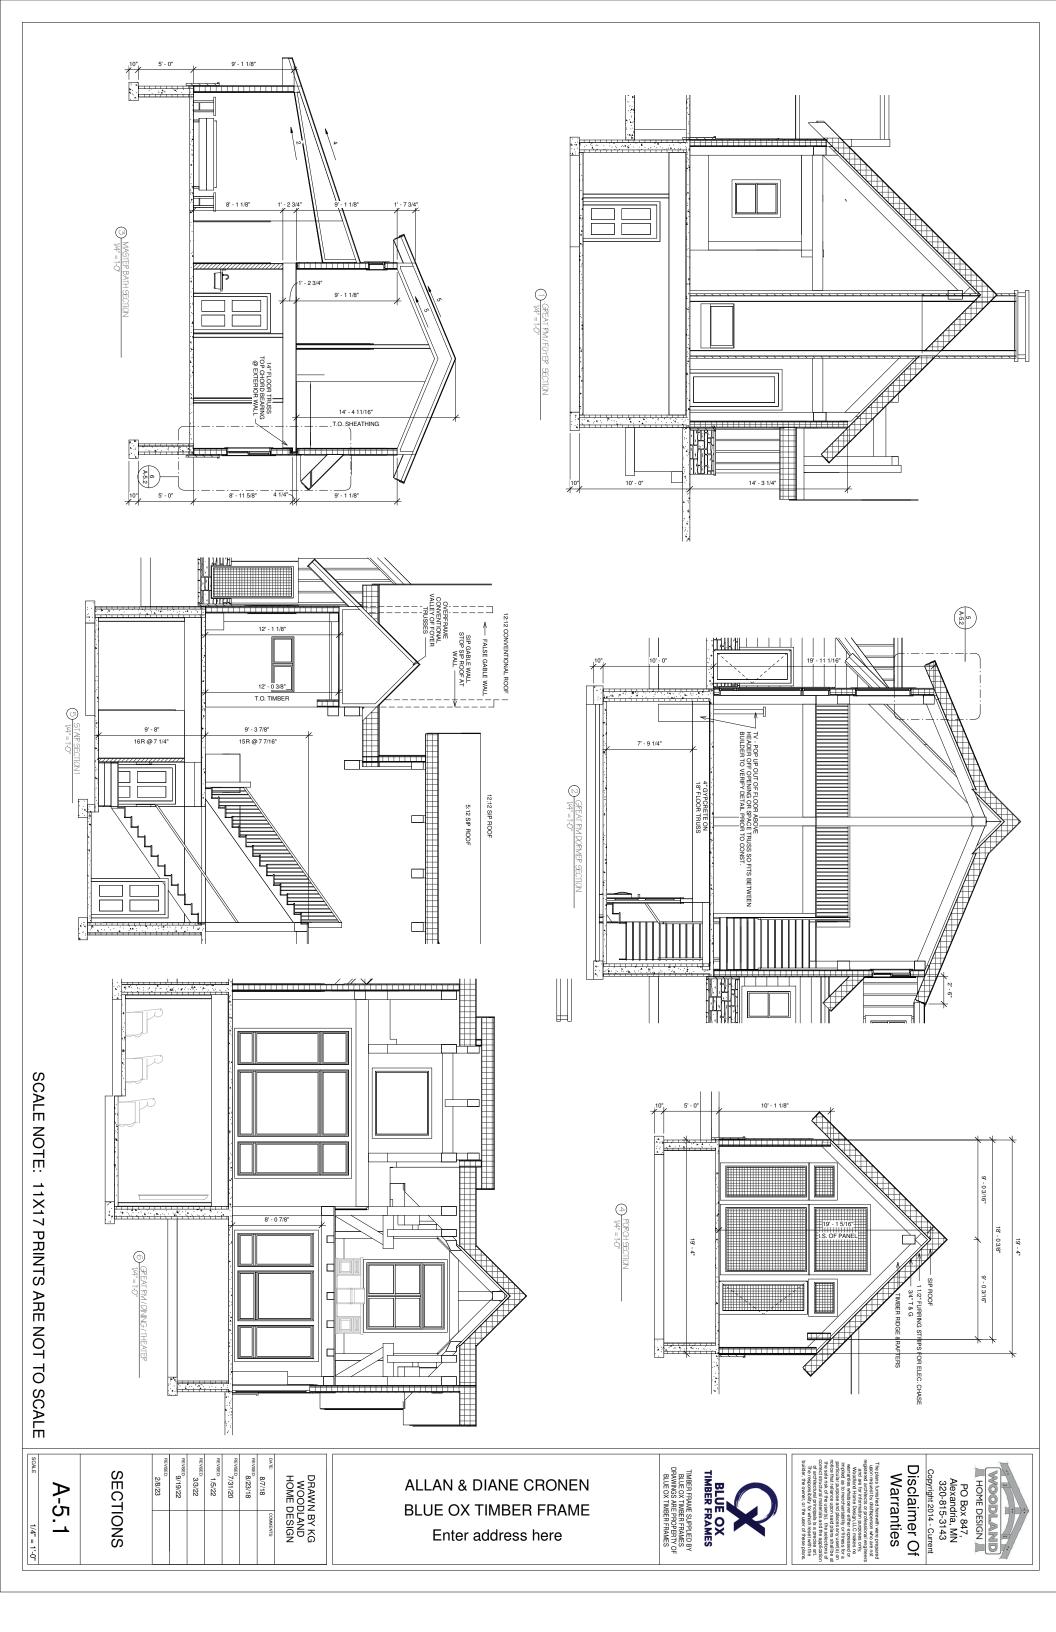
SCALE NOTE: 11X17 PRINTS ARE NOT TO SCALE


SECOND FLOOR PLAN REVISED 8/23/18 7/31/20 9/19/22 1/5/22 DRAWN BY KG WOODLAND HOME DESIGN 2/8/23 3/3/22 8/7/18 ₽-4 1/4" = 1'-0"

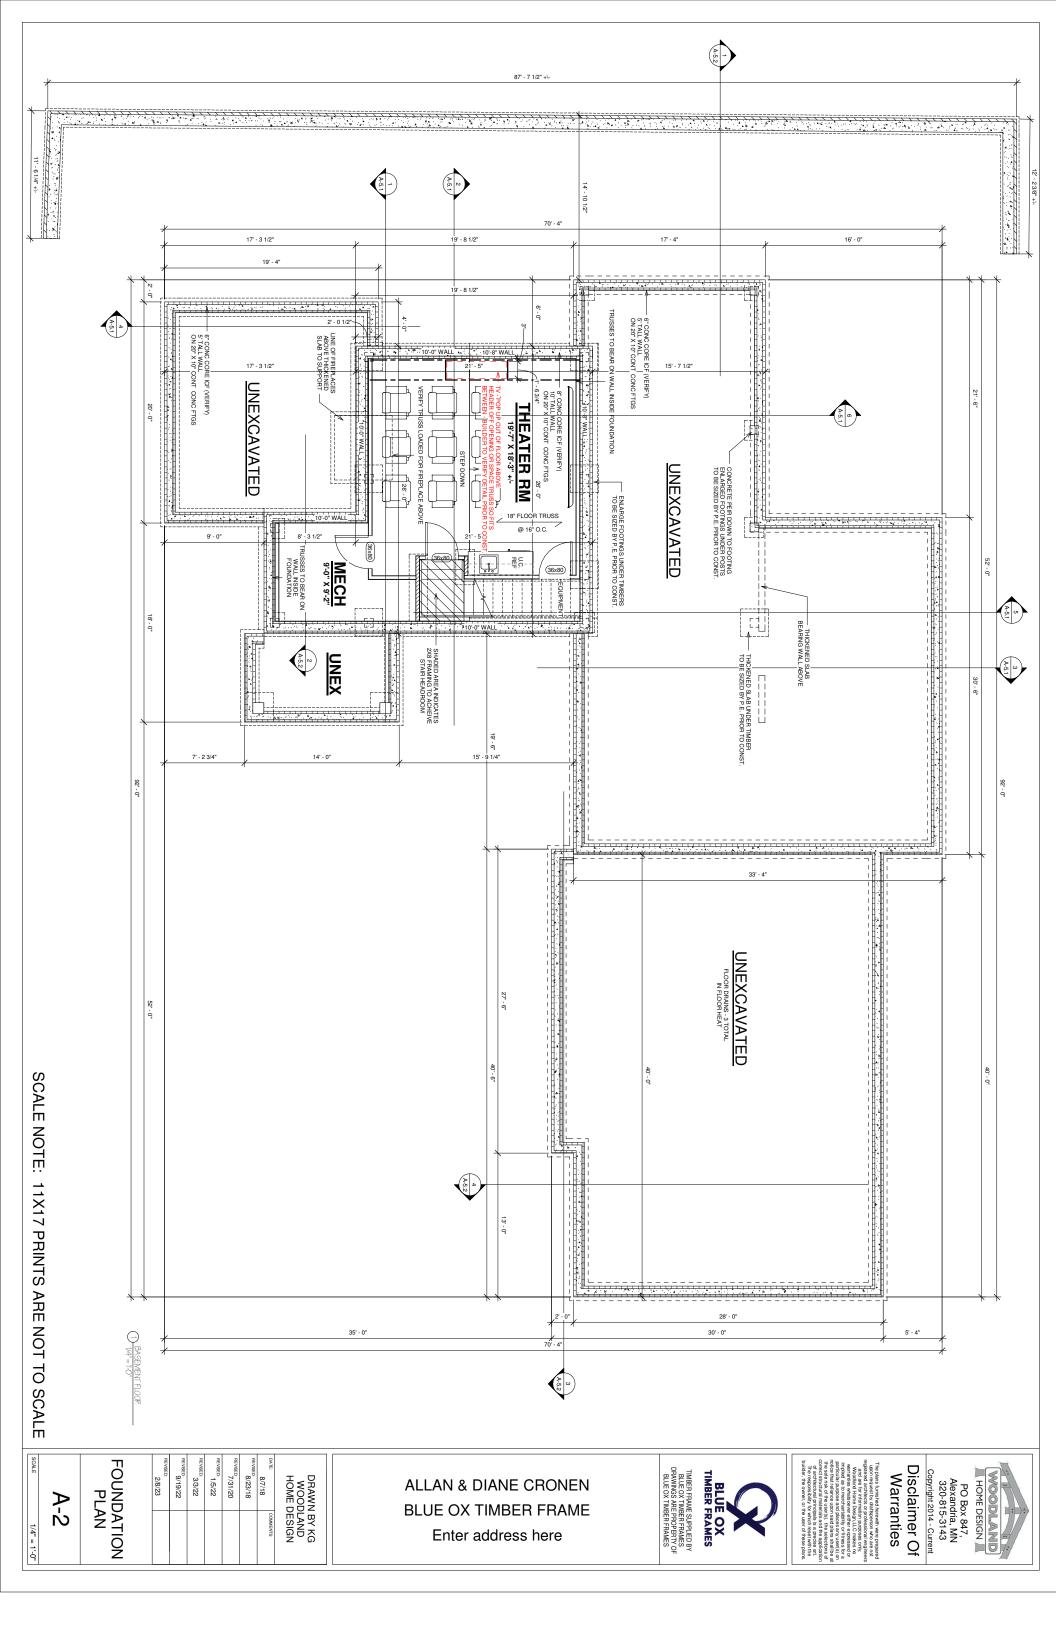
ALLAN & DIANE CRONEN BLUE OX TIMBER FRAME Enter address here

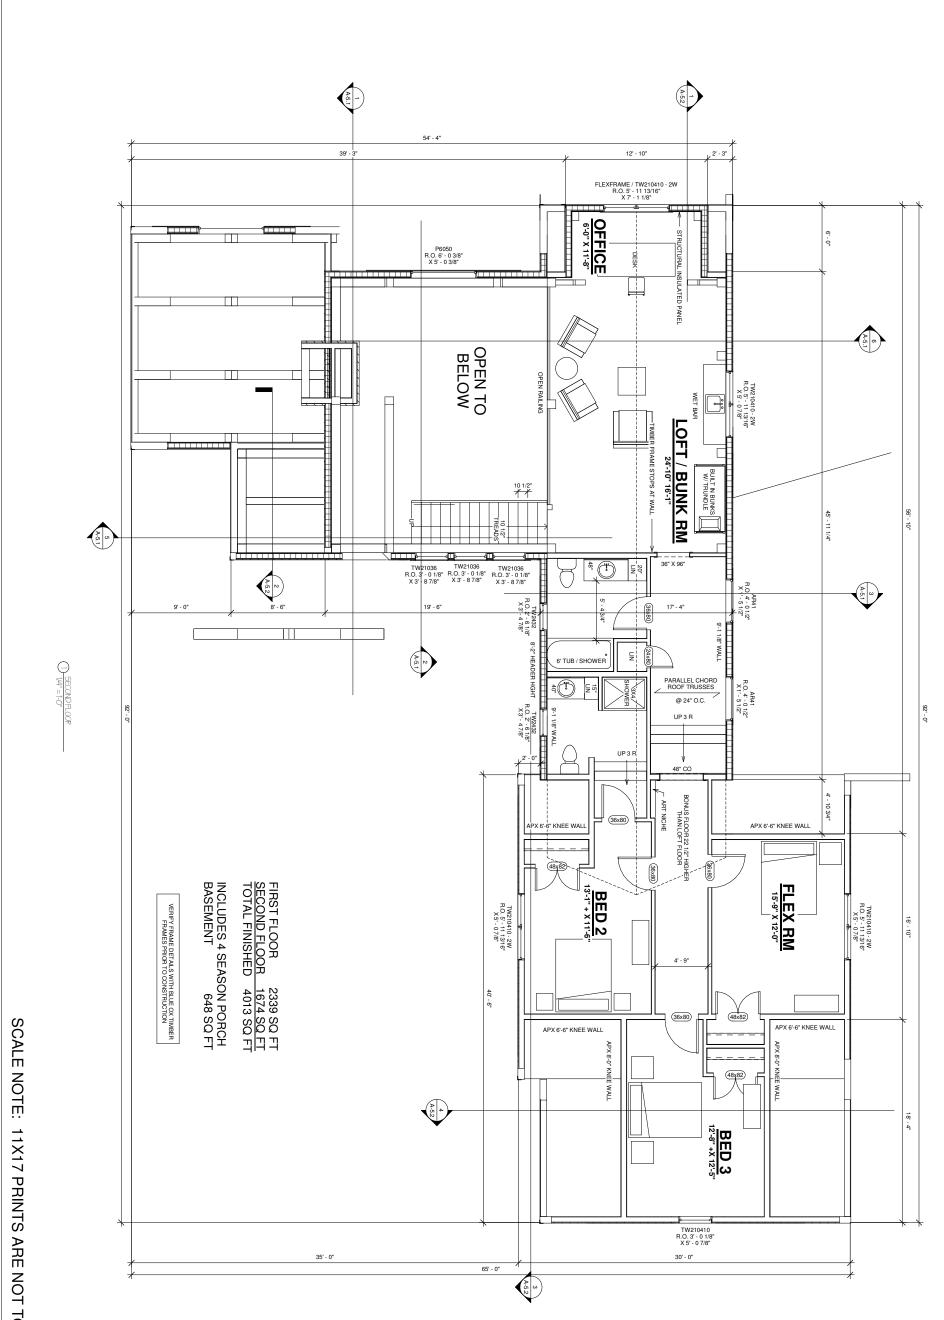



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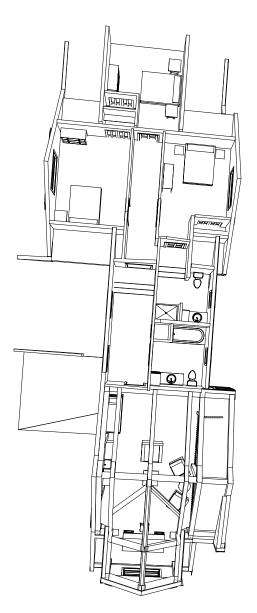





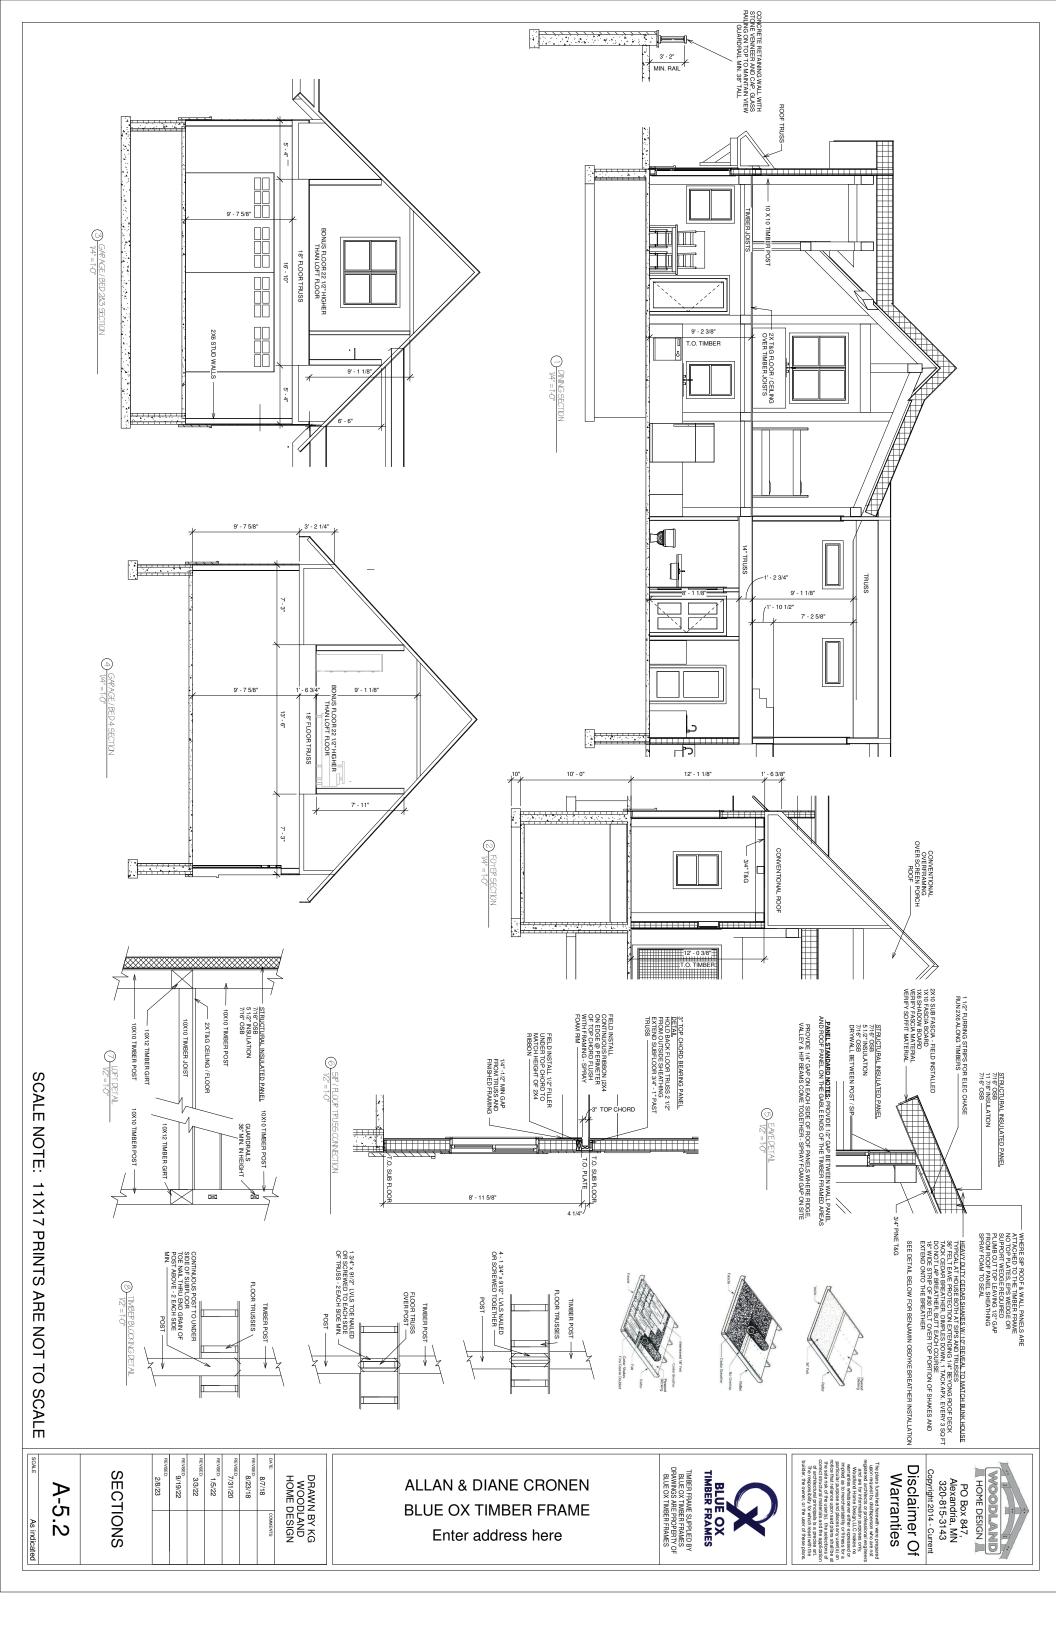

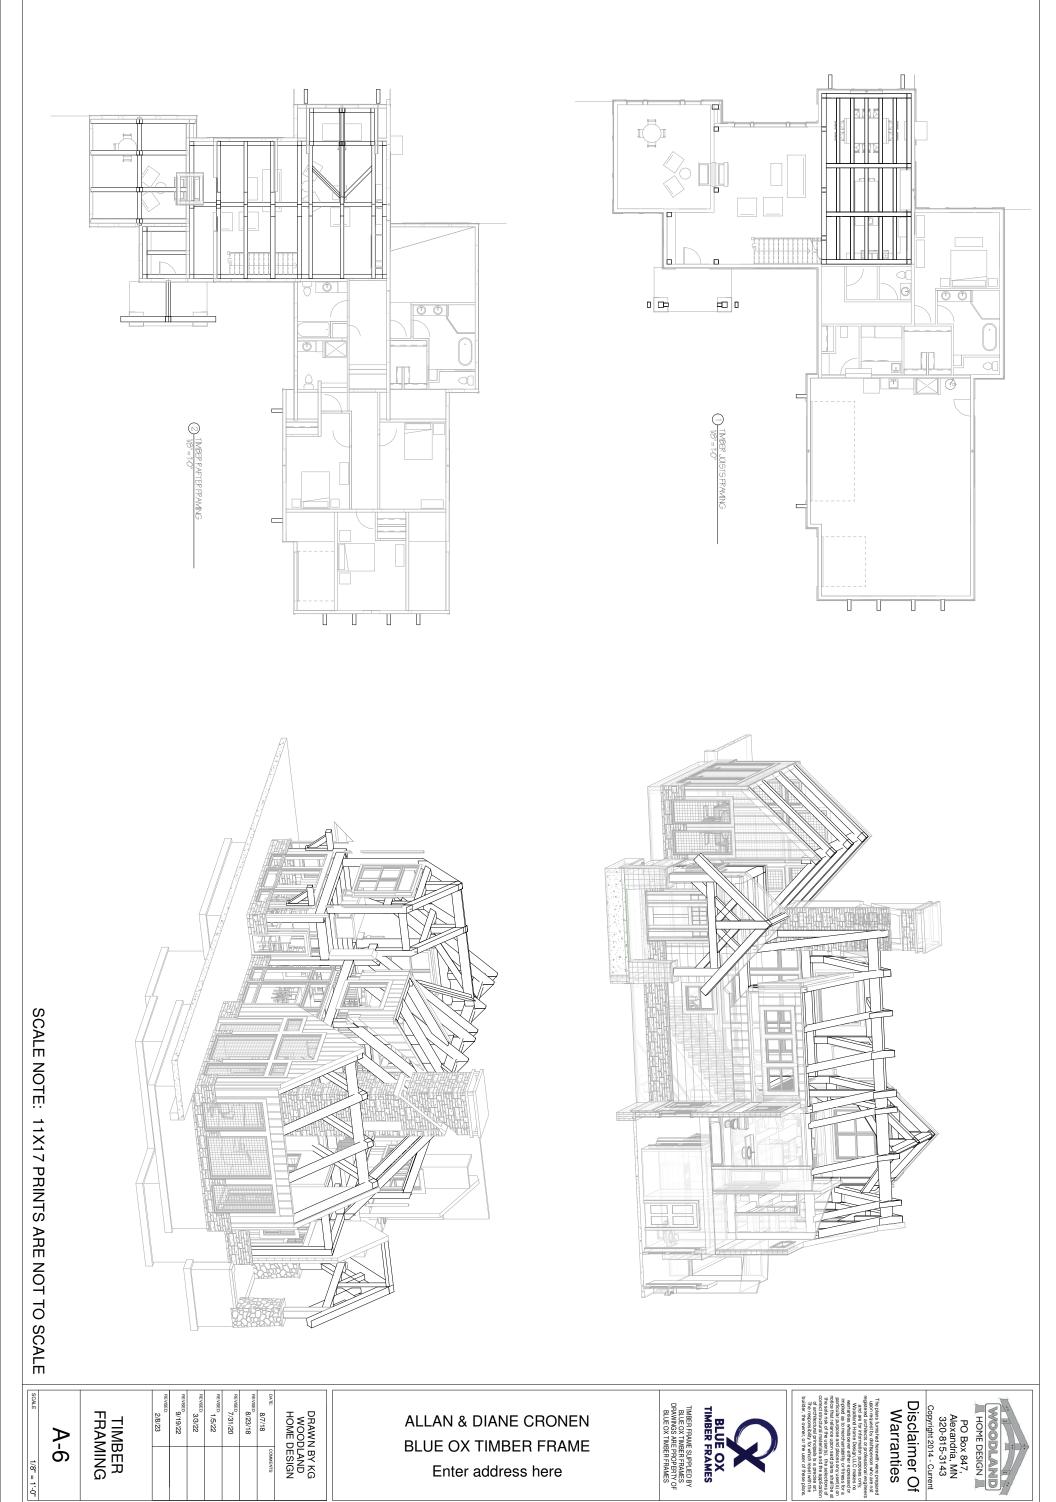

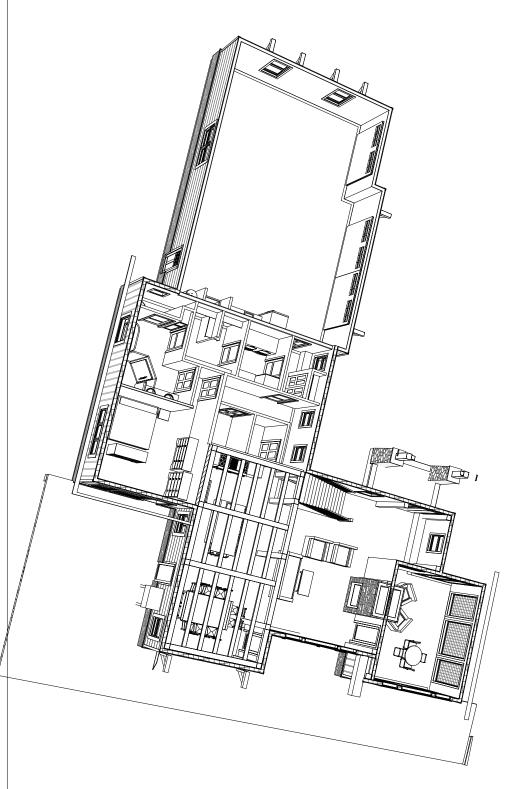

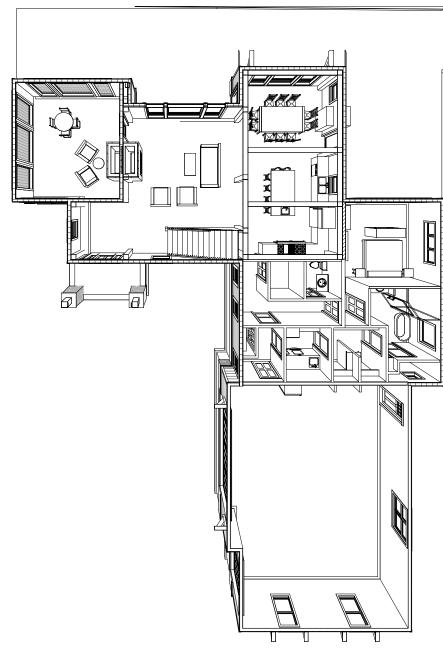

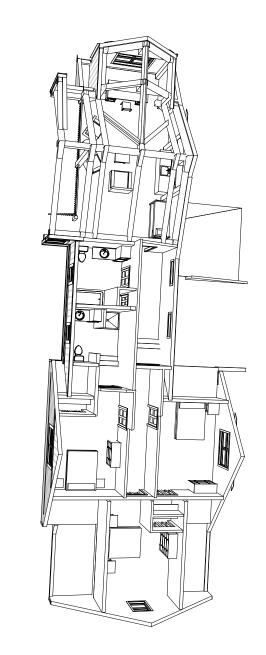

 Α-	INTER VIE	REVISED: 2/8/23	9/19/22	REVISED: 3/3/22	REVISED: 1/5/22	7/31/20	REVISED: 8/23/18	DATE: 8/7/18	DRAWN BY KG WOODLAND HOME DESIGN
7	ERIOR EWS							COMMENTS:	I BY KG DESIGN

ALLAN & DIANE CRONEN
BLUE OX TIMBER FRAME
Enter address here



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WOODLAND
HOWE DESIGN
PO Box 847,
Alexandria, MN
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Warranties

WANNEBO EXCVATING, INC.

12015 COUNTY ROAD #1 MANHATTEN BEACH, MN 56442 PHONE: 218-543-4544

Wannebo@tds.net

HyTec Construction 11360 Business 371 Brainerd, MN 56401 APRIL 10th, 2023 218-829-8529 PAULS@HYTECONSTRUCTION.COM


RE: ALLAN Cronen - New Home Construction 12292 Manhattan Point Blvd. Crosslake, MN 56442

- ** PATIO FILL WITHIN THE BLUFF IMPACT ZONE: APPROXIMATELY 100 YARDS OF CLEAN FILL
- ** PATIO FILL WITHIN THE BLUFF SET BACK ZONE: APPROXIMATELY 25 YARDS OF CLEAN FILL
- ** BASEMENT EXCAVATION WITHIN THE BLUFF SET BACK ZONE: APPROXIMATELY 300 YARDS OF MATERIAL.

PLEASE LET US KNOW IF YOU HAVE ANY QUESTIONS.

THANK YOU,

ISSAC WANNEBO
OWNER/ESTIMATOR

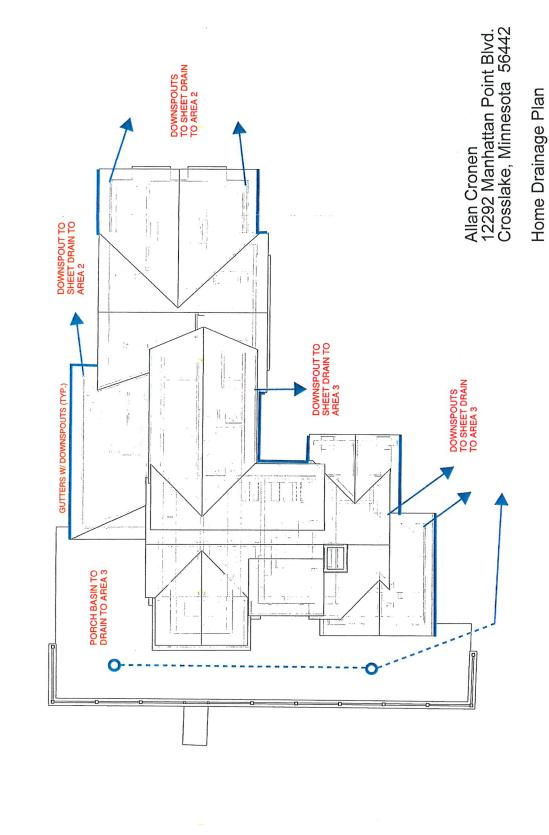



Anderson Brothers Construction Company 11325 State Highway 210 Brainerd, Minnesota 56401 218.829.1768

Regular Inspection and Maintenance Guidance for Porous Pavements

Regular inspection and maintenance is critical to the effective operation of porous pavement. It is the responsibility of the owner to maintain the pavement in accordance with the minimum design standards. This page provides guidance on maintenance activities that are typically required for these systems, along with the suggested frequency for each activity. Individual systems may have more, or less, frequent maintenance needs, depending on a variety of factors including the occurrence of large storm events, seasonal changes, and traffic conditions.

Inspection Activities

Visual inspections are an integral part of system maintenance. This includes monitoring pavement to ensure water drainage, debris accumulation, and surface deterioration.

drainage, debris accumulation, and surface deterioration.	
ACTIVITY	FREQUENCY
Check for standing water on the surface of the pavement after a precipitation event. If standing water remains within 30 minutes after rainfall had ended, cleaning of porous pavement is recommended.	
Vacuum sweeper shall be used regularly to remove sediment and organic debris on the pavement surface. The sweeper may be fitted with water jets.	
Pavement vacuuming should occur during spring cleanup following the last snow event to remove accumulated debris, at minimum.	
Pavement vacuuming should occur during fall cleanup to remove dead leaves, at minimum.	2 to 4 times per year, more frequently for high use sites or sites with higher potential for run-
Power washing can be an effective tool for cleaning clogged areas. This should occur at mid pressure typically less than 500 psi and at an angle of 30 degrees or less.	on
Check for debris accumulating on pavement, especially debris buildup in winter. For loose debris, a power/leaf blower or gutter broom can be used to remove leaves and trash.	
Check for damage to porous pavements from non-design loads. Damaged areas may be repaired by use of infrared heating and rerolling of pavement. Typical costs may be 2,000/ day for approximately 500 ft of trench.	1
Maintenance Activities Routine preventative cleaning is more effective than corrective	alcaning
Activity	Frequency
Controlling run-on and debris tracking is key to extending the life of porous surfaces. Erosion and sedimentation control of adjacent areas is crucial. Vacuuming adjacent non porous asphalt can be effective at minimizing run-on.	Whenever vacuuming adjacent porous pavements
Repairs may be needed from cuts of utilities. Repairs can be made using standard (non-porous) asphalt for most damages. Repairs using standard asphalt should not exceed 15% of total area.	
Do not store materials such as sand/salt, mulch, soil, yard waste, and other stock piles on porous surfaces.	
Stockpiled snow areas on porous pavements will require additional maintenance and vacuuming. Stockpiling on snow on porous pavements is not recommended and will lead to premature clogging.	As needed
Damage can occur to porous pavement from non-design loads. Precautions such as clearance bars, signage, tight turning radius, high curbs, and video surveillance may be required where there is a risk off non-design loads.	
Posting of signage is recommended indicating presence of porous pavement. Signage should display limitation of design load (i.e. passenger vehicles only, light truck traffic, etc. as per pavement durability rating.)	

CHECKLIST FOR INSPECTION OF POROUS PAVEMENTS

Location: Allan Cronen


12292 Manhattan Point Blvd. Crosslake, Minnesota 56442

nspection Items Satisfactory (S) or Unsatisfactory (U)		Comments/Corrective Action	
1. Salt / Deicing *Note complete winter maintenance guidance	is available	at UNHSC	
Use salt only for ice management	S	U	
Piles of accumulated salt removed in spring	S	U	
2. Debris Cleanup (2-4 times a year minimum, Spring & Fall)			
Clean porous pavement to remove sediment and organic debris on the pavement surface via vacuum street sweeper.	s	U	
Adjacent non porous pavement vacuumed	S	U	/
Clean catch basins (if available)	s	U]
3. Controlling Run-On (2-4 times a year)			
Adjacent vegetated areas show no signs of erosion and run-on to porous pavement	s	U	
4. Outlet / Catch Basin Inspection (if available) (2 times a year, A	fter large sto	orm events)	
No evidence of blockage	S	U]
Good condition, no need for cleaning/repair	S	U	
5. Poorly Drained Pavement (2-4 times a year)			
Pavement has been pressure washed and vacuumed	s	U	
6. Pavement Condition (2-4 times a year minimum, Spring & Fall)			
No evidence of deterioration	S	U]
No cuts from utilities visible	S	U	
No evidence of improper design load applied	S	U	
7. Signage / Stockpiling (As Needed)			
Proper signage posted indicating usage for traffic load	S	U	
No stockpiling of materials and no seal coating	S	U	

1.	
2.	
3.	



JOB Cronen Retain	any relati
MOREOUS AND THE REAL PROPERTY AND THE PR	JOB NO. 2023-10323
CALCULATED BY 144.P	DATE 3-13-23
OUEOVED DV	-

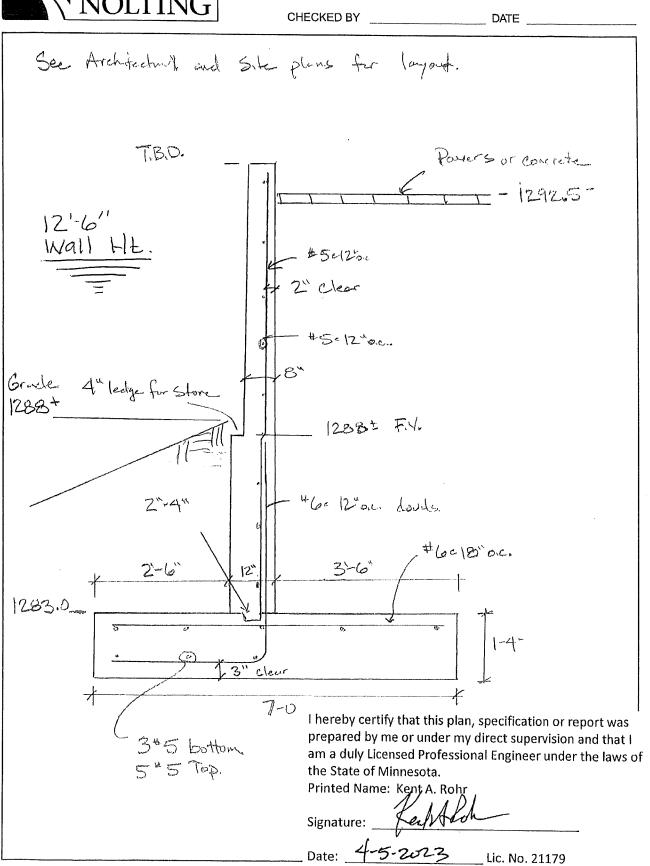

From: Frie, Jacob (DNR)

To: <u>Cheryl</u>

Cc: "Pete Gansen"; "pat wehner"; MN Ordinance Review (DNR)

Subject: RE: 5.26.2023 PC/BOA

Date: Thursday, April 20, 2023 9:18:10 AM

Attachments: image001.png

image002.png image003.png image004.png

Agency Underwood Real.pdf

Good afternoon Cheryl:

Concerning the Underwood Real Estate, LLC variance(s) application, the MN DNR offers the following comments:

The COS shows a significant existing bluff within the northern 1/3 of the property. The requests represent severe deviations to the Ordinance standard of 30 feet from the top of a bluff of mostly new construction. Physically, development that encroaches on bluff tops can accelerate soil erosion, loading, and slope failure. Aesthetically, development that encroaches on bluff tops can compromise or eliminate the natural appearance of this topographic feature in shoreland areas. Therefore, they are important areas to avoid new or expansion of existing infrastructure where feasible and practicable.

As this is a new construction (i.e., scrape and re-build) project on 2 parcels of record with substantial buildable area (likely more than 18,000 sq. ft), there appears to available buildable area on the parcels for the entire project to move backwards, away from the bluff impact zones. The rear lot area is topographically flat, with the septic tanks being located apx. 54 feet from the proposed rear of the attached garage. Therefore, with a re-design of the parking areas and stormwater management plan, the projects could be moved perhaps up to 40 feet to the rear of the lot to still meet minimum septic tank setbacks (10 feet) and drainfield setbacks (20 feet).

The DNR strongly suggests a revised alternative to this proposal in order to better comply with the variance acceptance criteria parts 26-225 (3) a, c, and d of the Crosslake Land Use Ordinance – and therefore does not recommend approval of the current proposal.

Thank you for your time.

Jacob Frie

Area Hydrologist | Division of Ecological and Water Resources

Minnesota Department of Natural Resources

1601 Minnesota Drive Brainerd, MN, 56401

Phone: 218-203-4367

Email: Jacob.frie@state.mn.us

mndnr.gov



Variance Application
Planning and Zoning Department
13888 Daggett Bay Road, Crosslake, MN 56442
218.692.2689 (Phone) 218.692.2687 (Fax) www.cityofcrosslake.org

on line

Receipt Number: 38236711 Property Owner(s): Allan Cronen - Underwood Real Estate LLC	Permit Number:	230036√
	Va	riances
Mailing Address: 7388 Point Lake Drive, Willmar, MN 56201		licable requests)
Site Address: 12292 Manhattan Point Blvd.	☐ Lake/Ri	ver Setback
Phone Number: 320.221.3381	☐ Road Ri	ight-of-Way Setback
E-Mail Address: acronen@gvlpoly.com	■ Bluff Se	etback
Parcel Number(s): 14060875 and 14060874	☐ Side Ya	rd Setback
Legal Description: Lots 5 and 6, Block 4 - Manhatten Beach	☐ Wetland	ł Setback
Sec6 Rge_ 26 27 28	☐ Septic T	Tank Setback
Lake/River Name: Trout Lake	☐ Septic I	Orainfield Setback
Do you own land adjacent to this parcel(s)? Yes No	☐ Impervi	ous Coverage
If yes list Parcel Number(s)	☐ Accesso	ory Structure
Authorized Agent: Paul Skogen - Hy Tec Construction	│ □ Buildin	g Height
Agent Address: 11360 Business 371- Brainerd, MN 56401	☐ Patio Si	
Agent Phone Number: 218.829.8529		. 1
Agent Fnone Number.	A 4	Impact 106 Cy Setback 325 Cy
		/
Signature of Property Owner(s)	Ε	o _{ate} January 26, 2023
Signature of Authorized Agent(s)	Γ	o _{ate} February 2, 2023
 All applications must be accompanied by a signed Certificate of S Fee \$500 for Residential and Commercial Payable to "City of Cro No decisions were made on an applicant's request at the DRT me after DRT does not constitute approval. Approval or denial of ap Planning Commission/Board of Adjustment at a public meeting a City of Crosslake Land Use Ordinance. 	osslake",†36 cypeting. Submittal opplications is deterr	of an application mined by the
For Office Use: Application accepted by	Land Use	District_SD_
Lake Class Septic: Compliance Na SSTS Design	existing Insta	ıllation_/0-14-25



Practical Difficulty Statement

Pursuant to City of Crosslake Ordinance Article 8 – Variances may be granted when it is found that strict enforcement of the Land Use Ordinance will result in a "practical difficulty".

Please answer the following questions regarding the "practical difficulty" for your variance request.

1.	Is the Variance request in harmony with the purposed and intent of the Ordinance? Yes ■ No □ Why:
	Defer to the Planning Commission/Board of Adjustment
2.	Is the Variance consistent with the Comprehensive Plan? Yes ■ No □ Why: Defer to the Planning Commission/Board of Adjustment
3.	Is the property owner proposing to use the property in a reasonable manner not permitted by the Land Use Ordinance? Yes No Why: Construct a New Home and Patio Area in the Same Place as the Existing Cabin and Deck. Front of new home and patio will not exceed location of existing patio and cabin. There are similar homes in the neighborhood with similar bluff setbacks. The impervious surface coverage is below the 25% Maximum allowed by the Land Use Ordinance. Implementation of the storm water management plan will help protect water quality of Trout Lake
4.	Will the issuance of a Variance maintain the essential character of the locality? Yes No Why: There are similar structures in the area with similiar setbacks and land use patterns. North Side of the New Patio Area and Home will not exceed the bluff limits of the existing deck and home. North wall of the new home will be in alingment with adjacant properties. Implementation of Storm Water Management Plan will help protect water quality of Trout Lake. Minimal Visibility from Trout Lake.
5.	Is the need for a Variance due to circumstances unique to the property and not created by the property owner? Yes No Why: The lot was created prior to any zoning regulations established in 1979. This is an existing lot of record in the plat of Manhattan Beach (A Replat of Twin Beach) established in 1926. New Home and Patio will be constructed in the same area as the existing cabin and deck.
6.	Does the need for a Variance involve more than economic considerations? Yes No Why: Implementation of the Storm Water Management Plan will help protect the Water Quality of Trout Lake. New Home and Patio Area will in similar location as neighbors homes to the East and West.



City of Crosslake Planning Commission/Board of Adjustment

FINDINGS OF FACT SUPPORTING / DENYING A VARIANCE REQUEST

A Variance may be granted by the Planning Commission/Board of Adjustment when it is found that strict enforcement of the Land Use Ordinance will result in a "practical difficulty" according to Minnesota Statute Chapter 462. The Planning Commission/Board of Adjustment should weigh each of the following questions to determine if the applicant has established that there are "practical difficulties" in complying with regulations and standards set forth in the Land Use Ordinance.

there are "praction Land Use Ordina	cal difficulties" in complying with regulations and standards set forth in the nce.
1. Is the Variance Yes Why:	re request in harmony with the purposes and intent of the Ordinance? No
2. Is the Variance Yes Why:	e consistent with the Comprehensive Plan? No
3. Is the property the Land Use Yes Why:	y owner proposing to use the property in a reasonable manner not permitted by Ordinance? No

4.		iance of a Varia No	nce maintain th	e essential chara	acter of the locality	7?
	Is the need e property ov Yes Why?		due to circumst	ances unique to	the property and r	not created by
6.		ed for a Varian No	ce involve more	than economic	considerations?	